

**LEGISLATIVE COUNCIL REGULAR MEETING
COUNCIL CHAMBERS, 3 PRIMROSE STREET, NEWTOWN, CT
WEDNESDAY, DECEMBER 16, 2020**

MINUTES

PRESENT VIA TELECONFERENCE: Jordana Bloom (7:39 pm), Alison Plante, Chris Smith, Phil Carroll, Ryan Knapp, Judit DeStefano, Paul Lundquist, Chris Eide, Dan Wiedemann, Cathy Reiss, Andy Clure, Dan Honan

ALSO PRESENT: First Selectman Dan Rosenthal, Finance Director Bob Tait, 0 public, 2 press

CALL TO ORDER: Mr. Lundquist called the meeting to order with the Pledge of Allegiance at 7:32 pm.

VOTER COMMENT: None

MINUTES: Mr. Honan moved to accept the minutes with the below edits made of the December 2, 2020 Legislative Council Regular Meeting. Seconded by Mr. Eide. All in favor. Motion passes (12-0).

Mr. Eide stated that there were errors to the following motions from the December 2nd minutes. They should read as noted below:

Mr. Honan moved to have the town attorney give a legal opinion on the three ordinances. Seconded by Mr. Smith. ~~Motion rescinded.~~

Mr. Eide moved to make an amendment to the previous motion to ~~instead have the town attorney give a legal opinion on a proposal to ban open carry on public property.~~ Seconded by Ms. DeStefano. Motion ~~to amend~~ passes (9-3).

~~Vote on amended motion to have the town attorney give a legal opinion on a proposal to ban open carry on public property passes (7-5).~~

COMMUNICATIONS: More emails received regarding the proposed gun ordinances from the December 2nd meeting. *See attachment A.*

COMMITTEE REPORTS:

Education Committee – None

Finance Committee – None

Municipal Operations Committee – None

Ordinance Committee – Mr. Knapp had Kinga Walsh, Chair of the Community Center Committee, present at their last meeting. They discussed some issues and are working through them together.

Charter Revision Interview Committee – Mr. Wiedemann stated that the ad to recruit members for the interview process will be posted in this week's issue of the Newtown Bee.

Charter Revision Charge Committee – Ms. DeStefano said that they met last week and spoke on hoping to get feedback from boards and commissions by January 25th. They discussed some potential issues that they would like to see worked on and if anyone else has other items to add, please submit to Ms. DeStefano.

FIRST SELECTMAN'S REPORT: First Selectman Dan Rosenthal gave an update on the Eversource investigation. The four towns involved testified all day at a hearing this past Monday. The testimony was pre-filed and they had to speak to it during cross-examination by PURA, DEEP, and Eversource's attorneys. It appeared that PURA really understood the issue and it was a successful day. The process remains ongoing and they will not be due to render any decision until late Winter/early Spring. Mr. Clure commented that he is very appreciative of the First Selectman's hard work and involvement with the Eversource investigation.

First Selectman Rosenthal ended with reporting that the new system in the Council Chambers is ready and fully functional.

NEW BUSINESS

Discussion and Possible Action

- 2021-22 – 2025-26 CIP

Mr. Lundquist opened up the discussion by asking for general comments and questions regarding the town's CIP projects. *See attachments B and C.* He will invite the appropriate parties like the BOE and Public Building and Site for further detailed discussion to one of the next LC meetings in January – the LC has 60 days from December 2nd to complete the process. Most of the revisions were project costs attributed to the Hawley HVAC project which now totals about \$8 million. *See attachment D.* This helped drive a lot of the other changes that the BOF had to contend with in getting us the CIP. Even with these revisions, the debt service remains well under our debt cap. The CIP is solid and our debt cap is at 9% until July 1, 2023 where, by policy, it has to be at 8.5%. and it has to be at 8%.

Mr. Smith asked to have further detail from the BOF regarding the Hawley HVAC project. He would like to see other alternatives or if there are other scenarios on how the increase could be handled. The First Selectman commented that there will be more discussion as the numbers become more firm and whether this will even make the April referendum, and that a November referendum seems more likely.

Mr. Knapp's takeaway from the last set of minutes from the BOF meeting was that they were caught off guard. He's not sure the BOF had the opportunity and awareness that this would essentially double in cost - they approved the CIP but they didn't have the opportunity to run around the numbers. He is concerned that the numbers will come in higher.

Ms. Reiss asked about the Middle School investigating their own HVAC system and how a school closure would be handled. Mr. Knapp felt it was worth noting that the numbers have continued to climb; a lot of money has already been spent on the heating system and feels there would've been a cheaper alternative had they done something differently years ago. It's more of a big picture topic when they try selling this to the voters when it's time to go to referendum. Mr. Lundquist interjected that this topic is something that he does not want to get into without the BOE present. Ms. DeStefano agreed and feels we are beyond the scope of what this conversation should be about.

Mr. Knapp stated that the number doubled and ultimately it is the Council's responsibility to put forth the proper information to the voters. He is disappointed that no one ever had clarity that we were off by a factor of two. He is concerned about putting forth something that may fail.

Mr. Honan asked if someone from Public Building and Site could be present to discuss the Hawley project.

Mr. Carroll expressed his concerns with the increasing costs. He feels that the BOE's numbers don't stay firm, they increase with every large project presented.

Mr. Wiedemann feels that the BOE should address or research the project further. He believes that even if we put this amount of money into this building, we will still end up with a building that is not ADA complaint simply due to the age of the building, and we should examine it further before making any final decisions.

Ms. Reiss noticed the Sandy Hook Permanent Memorial will start in year one, what is the process for that? The First Selectman replied that sometime in early January we will have a final budget and design. The goal would be to have this on the ballot in April.

Mr. Smith asked to hear from the library group, and noted their numbers have gone up as well. The First Selectman stated that nothing has changed with the library's budget but that some of the funds moved around from year to year. However, the BOF added more money to the paving project at the library. Mr. Tait confirmed that there were no changes with the exception to the paving.

Ms. Reiss asked for clarification about the cleanup of 28A Glen Road. First Selectman Rosenthal stated that this is a town owned property which currently has grant funding going towards cleanup around the property. Eventually they will need more money to take the building completely down.

Regarding the turf replacement at the high school, Mr. Wiedemann asked if it is really a necessity to be done this year given the current situation with Covid and decreased use of the fields due to sports cancellations; and could Park and Rec combine this with some of the other field replacements to do at once to cut back on some costs. Ms. Reiss would also like to know what the increase by \$45,000 is for.

Ms. Plante asked about the Batchelder Park project presented at \$1.4 million in year five, do we know and what that number would be used for. The First Selectman replied that we would not be using any of the town money towards this one – it will be all grant money. Park and Rec would like to create some trail connectivity there that runs through Monroe.

Mr. Smith asked if the Emergency Radio project remains the same and also asked why the Fire numbers went up by \$300,000. The First Selectman responded that the emergency radio dispatch equipment is in the process of being installed and we will have a final number for that in January. In regards to the Fire apparatus, he stated there was a swap in years for a tanker. Ms. Plante asked if there is a market to sell the old vehicles. Mr. Rosenthal said that we do sell them but usually do not fetch much money for them.

Mr. Wiedemann asked why there is no money allocated in year one towards bridges. Mr. Tait said there are about \$800,000 in appropriations available for bridges and therefore do not need more for this year. Mr. Wiedemann also asked if the money allocated to Fairfield Hills building remediation in year two is enough. The First Selectman said later on we will have a better idea of what buildings a builder would like to pursue and would more than likely put forward an appropriation next year for the total amount.

Mr. Honan asked about the paving project at Edmond Town Hall in year two and what the leanto's of the dumpsters. Mr. Lundquist said he will get clarification on that.

To conclude, Mr. Lundquist stated he had notes to get clarification around the library numbers, and to follow up with the BOE and Public Building and Site. Mr. Clure then asked if he could add Rick Spreyer, the town's Purchasing Agent, to be included in the next meeting as well.

Mr. Lundquist also wanted to say for the record that his wife works part-time as a Paraeducator at Hawley School, and this will not affect his votes or his conversation.

VOTER COMMENT: None

ANNOUNCEMENTS: None

ADJOURNMENT: There being no further business, Ms. DeStefano moved to adjourn the meeting at 8:34 pm. Seconded by Ms. Reiss. All in favor.

*Respectfully submitted,
Rina Quijano, Clerk*

**THESE MINUTES ARE SUBJECT TO APPROVAL BY THE LEGISLATIVE COUNCIL
AT THE NEXT MEETING.**

Attachment A

Your name: Kenneth Robertson

Your e-mail address: kcrmusic@kc.rr.com

Subject: Gun Violence

Message:

I approve to all of the following:

1. prohibiting gun owners from openly carrying their firearms in town
2. prohibiting on town-owned property such as Fairfield Hills and the Newtown Municipal Center
3. prohibiting intimidation at public demonstrations/protests/rallies/marches/vigils.

Your name: Jerry Li

Your e-mail address: jerrylili@gmail.com

Subject: Comment on NAA Proposal to ban

Message:

Hello,

My name is Jerry Li and I would like to comment on the NAA proposal to ban firearm carry on town property, at demonstrations, and open carry in general.

I believe in the 2nd Amendment but I also believe in the safety of residents.

CT has one of the strictest laws in place to purchase firearms, as a result of what happened in Newtown in 2012. From reading the NAA proposal, I do not see any valid genesis for any of these new proposed rules. What has happened recently that triggered the need for these new rules? Gun laws are a fine balance between maintaining 2A rights under the constitution and legislating rules to ensure safety for the public. Careful consideration need to be made every time, but I just don't see enough of benefit to the public that outweighs infringement of 2A rights at this time for these specific proposals.

I'm a Stamford resident and in 2012 I was working at GE Capital in Stamford, in the same building where Peter Lanza worked. For weeks that was the hard tragedy that effected my work community immensely. I'll never forget where I was and what I was doing when I head the news. And I'm sure it's the same for the members of NAA. But we have to move on. Law abiding permit holders did not commit those acts in 2012. Removal of all civilian firearms would stop such events in the future but it's simply against our constitution, NAA needs to find another way to prevent such acts.

Sincerely,

Jerry Li

Stamford, Conn

12/7/2020

Your name: Daniel Pierce

Your e-mail address: piercedaniel@att.net

Subject: Open Carry

Message: CT is already an open carry state although it's a farce since if I were to carry openly that it would cause chaos. I am a law abiding citizen and carry frequently. There is no boundary that turns me into a mass murderer. Town property or private I am the same conscience person. In a larger picture I feel the same about state restrictions.

Your name: Michael Pantano

Your e-mail address: mpantano7@gmail.com

Subject: Proposed gun ordinances

Message:

I have been living in Newtown for 11 years. I love this town and I truly care about its future. The proposed ordinances are more examples of increasing government over reach by ignorant and scared people. They are not only unconstitutional, but counterproductive to the ultimate goal of making Newtown and our state a safe place for our children to live. The tragedy at Sandy Hook has NOTHING to do with law abiding citizens practice their right to bear arms on town property. We need more armed officers in schools, and more responsible citizens concealed carrying in town. So-called "Gun Free Zones" have proven to be targets for psychotic people hell-bent on causing harm to others. Groups like the Newtown Action Alliance are creating a problem where one does not exist just to push their extreme agenda. Please vote down this mis-guided legislation. Thank you!

Mike Pantano

8 Pine Tree Hill Rd

Newtown, CT

Your name: Joe Harrington

Your e-mail address: joeyharrington1997@yahoo.com

Subject: Firearm ordinances

Message: I have lived in Newtown my entire life. I understand how tragic the shooting was believe me, I was a freshman at NHS when it happened. But my question is why are law abiding gun owners being punished? No one has the right to infringe any constitutional rights period. I do not accept these proposed ordinances they're a direct attack on every legal gun owner in Newtown/Connecticut. Please do not pass these ordinances.

Your name: Shelley Minden

Your e-mail address: shelleyminden@msn.com

Subject: Preventing armed intimidation

Message:

I remember living near Newton many years ago -- a beautiful and peaceful city. Please keep it that way by changing gun laws to prevent armed intimidation.

Thank you for your consideration.

Subject: Newtown Freedoms

Good day,

I would like to respond to the “protect the Newtown citizens” proposal to ban guns in our town. I am a Sandy-hook/Newtown citizen and home owner. I have grown up around guns my entire life and have taken the required skills and documentation to carry a gun in the state of Connecticut. For me it’s more of an enjoyment of target shooting, but if needed I have the skills to protect myself.

My thought on the choice to carry is a freedom we have been given, but also that freedom should come with guidelines. Guns will never disappear, bad people will always find a way to get a gun. The citizens that choose to carry go through a long expensive process with training to be able to carry in Connecticut. These are not the ones you should be fearing. I believe we should focus on education and training of guns and how to properly use them. The second item I believe is important, mental health is not addressed like it should be. It often gets overlooked or brushed under the rug. If a person doesn’t want a gun that is their choice just as someone that goes through state policies to have a gun is their choice also.

As a citizen we have the ability to make choices, whether good or bad. We need to remember we do not live in a perfect world and getting rid of something doesn’t always solve the problem. Education and awareness are key.

Thank you and have a great day!

Wendy J. Stone

Subject: 2nd amendment concerned town resident

Good morning

As a long time Newtown resident, I would like to express my concerns and opposition to any change in law regarding my second amendment rights. I just recently became aware of the NAA trying to ban the carry of fire arms in certain parts of town. I strongly oppose this. As our town legislative team I implore you to not consider pursuing this any further.

Thank you for your time and consideration

Troy Simek

Change in Bonded Amounts: 2020-21 approved vs BOF 2021-22 Recommended		
	11/30/2020	
		2021-22
* Library Renovations (\$750,000); \$200,000 kept in 2021-22; \$550,000 moved to 2022-23		(550,000)
* Hawley Ventilation & HVAC split over 3 years (total increased from \$3,962,000 to 8,000,000) 3 year split = yr 1 - \$1,500,000; yr 2 - \$2,500,000; yr 3 - \$4,000,000.		(2,462,000)
* High School Turf Field (\$750,000); increased by \$45,000 (6%)		45,000
* Hawley New Generator (\$250,000); Reed School Gas Boiler/LED Lighting (\$1,539,894) Moved from prior year 6		1,789,894
* Head O' Meadow Boiler Plant & Lighting in prior year 4 was split into two. Head O'Meadow Lighting was moved to 2021-22 (\$425,000); Head O'Meadow Boiler Plant is in 2023-24 (\$425,000)		425,000
		(752,106)
		2022-23
* Fire Apparatus (\$535,000); S.H. tanker & S.H. ladder switched years 2022-23 & 2023-24; \$50,000 was added to both.		(85,000)
* Additional amount for clean up of 28A Glen road		650,000
* Edmond Town Hall theatre renovation was taken off (was amended and completed in prior year)		(250,000)
* Library renovations - \$550,000 was moved from 2021-22 (see above) & planned 2022-23 amount was moved to 2023-24 (\$650,000)		550,000
		(650,000)
* Reed School Gas Boiler/LED (\$1,452,730) moved to year 1 2021-22		(1,452,730)
* Hawley Ventilation & HVAC (2 of 3)		2,500,000
* Middle School HVAC Design (formally Middle School Improvements Design) moved to 2023-24		(300,000)
		962,270
		2023-24
* Library Renovations pushed to 2023-24 from prior year (see above) \$396,000 added to Library Renovations to properly reflect paving component		650,000
		396,000
* Head O'Meadow School Boiler Plant & Lighting (\$997,672); reduced by \$147,672 & Lighting component was moved to 2021-22 (\$425,000)		(147,672)
		(425,000)
* Fire Apparatus switch (see above) added \$235,000 to project. This was proposed to be funded by capital & non-recurring.		-
* Hawley Ventilation & HVAC (3 of 3)		4,000,000
* Middle School HVAC (formally Middle School Improvements) moved to 2025-26 due to increase in Hawley Ventilation & HVAC project		(3,568,140)
* Middle School HVAC Design moved from 2022-23		300,000
		1,205,188
		2024-25
* Zero Bonding Year		-0-
	TOTAL CHANGE	1,415,352

Town of Newtown

Board of Finance - Recommended 2021-22 to 2025-26 CIP

(w/ 5 additional years to 2030-31 for informational purposes)



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TOWN OF NEWTOWN						
BOARD OF FINANCE RECOMMENDED CIP - (2021 - 2022 TO 2025 - 2026)						
2021 - 2022 (YEAR ONE)			Proposed Funding			
	Dept.	Amount Requested	Bonding	Grants	General Fund	Other
Capital Road Program	PW	3,000,000	500,000		2,500,000	
Bridge Replacement Program	PW	-	-			
Emergency Radio System Upgrades	ECC	5,041,933	5,041,933			
Sandy Hook Permanent Memorial	SH MEM	2,000,000	2,000,000			
Town Match - Grants (contingency)	ECON DEV	200,000				200,000
Clean Up of 7 & 28A Glen Road	ECON DEV	200,000	200,000			
Library Renovations / replacements / upgrades	LIB	200,000	200,000			
Hawley School - Ventilation & HVAC (1 OF 3)	BOE	1,500,000	1,500,000			
Hawley School - New Generator	BOE	250,000	250,000			
High School - Replace/Restore Stadium Turf	BOE	795,000	795,000			
Reed School - Install Gas Boiler/LED Lighting	BOE	1,539,894	1,539,894			
Head O'Meadow School - Lighting	BOE	425,000	425,000			
TOTALS	>>>>>>>	15,151,827	12,451,827	-	2,500,000	200,000
2022 - 2023 (YEAR TWO)			Proposed Funding			
	Dept.	Amount Requested	Bonding	Grants	General Fund	Other
Capital Road Program	PW	3,000,000	250,000		2,750,000	
Bridge Replacement Program	PW	400,000	400,000			
Replacement of Fire Apparatus	FIRE	450,000	450,000			
Sandy Hook Permanent Memorial	SH MEM	2,000,000	2,000,000			
Clean Up of 28A Glen Road	ECON DEV	650,000	650,000			
Town Match - Grants (contingency)	ECON DEV	200,000				200,000
Building Remediation & Demo / Infrastructure	FHA	2,000,000	2,000,000			
Edmond Town Hall Parking Lot Improvements	ETH	450,000	450,000			
Library Renovations / replacements / upgrades	LIB	550,000	550,000			
Hawley School - Ventilation & HVAC (2 OF 3)	BOE	2,500,000	2,500,000			
TOTALS	>>>>>>>	12,200,000	9,250,000	-	2,750,000	200,000
2023 - 2024 (YEAR THREE)			Proposed Funding			
	Dept.	Amount Requested	Bonding	Grants	General Fund	Other
Capital Road Program	PW	3,050,000	-		3,050,000	
Bridge Replacement Program	PW	400,000	400,000			
Multi-Purpose Building Electrical/Mechanical/HVAC	PW	413,000	413,000			
Municipal Center - Roof Remediation & Replacement	PW	1,000,000	1,000,000			
Replacement of Fire Apparatus	FIRE	1,035,000	800,000			235,000
Town Match - Grants (contingency)	ECON DEV	200,000				200,000
Library Renovations / replacements / upgrades	LIB	1,046,000	1,046,000			
Building Remediation & Demo / Infrastructure	FHA	1,500,000	1,500,000			
Lake Lillinonah Park Improvements	P & R	500,000				500,000
Hawley School - Ventilation & HVAC (3 OF 3)	BOE	4,000,000	4,000,000			
Head O'Meadow School - Boiler Plant	BOE	425,000	425,000			
Middle School HVAC - Design	BOE	300,000	300,000			
TOTALS	>>>>>>>	13,869,000	9,884,000	-	3,050,000	935,000
2024 - 2025 (YEAR FOUR)			Proposed Funding			
	Dept.	Amount Requested	Bonding	Grants	General Fund	Other
Capital Road Program	PW	3,100,000			3,100,000	
Town Match - Grants (contingency)	ECON DEV	200,000				200,000
TOTALS	>>>>>>>	3,300,000		-	3,100,000	200,000
2025 - 2026 (YEAR FIVE)			Proposed Funding			
	Dept.	Amount Requested	Bonding	Grants	General Fund	Other
Capital Road Program	PW	3,150,000	-		3,150,000	
Bridge Replacement Program	PW	400,000	400,000			
Replacement of Fire Apparatus	FIRE	750,000	750,000			
Building Remediation & Demo / Infrastructure	FHA	2,000,000	2,000,000			
Library Renovations / replacements / upgrades	LIB	1,000,000	1,000,000			
Edmond Town Hall Building Renovations	ETH	550,000	550,000			
Town Match - Grants (contingency)	ECON DEV	200,000	-			200,000
Treadwell Artificial Turf & Lighting	P & R	800,000	250,000			550,000
Rail Trail - Batchelder Park	P & R	1,400,000		1,400,000		
Middle School HVAC	BOE	3,782,228	3,782,228			
TOTALS	>>>>>>>	14,032,228	8,732,228	1,400,000	3,150,000	750,000
GRAND TOTALS		58,553,055	40,318,055	1,400,000	14,550,000	2,285,000

Town of Newtown, Connecticut
Capital Improvement Plan

'21/'22 thru '30/'31

PROJECTS & FUNDING SOURCES BY DEPARTMENT

Department	Project #	'21/'22	'22/'23	'23/'24	'24/'25	'25/'26	'26/'27	'27/'28	'28/'29	'29/'30	'30/'31	Total
Board of Education												
Hawley - Ventilation and HVAC	BOE-01	1,500,000	2,500,000	4,000,000								8,000,000
Bonding		1,500,000	2,500,000	4,000,000								8,000,000
High School - Replace / Restore Stadium Turf	BOE-02	795,000										795,000
Bonding		795,000										795,000
Reed - Install Gas Boiler / LED Lighting	BOE-03	1,539,894										1,539,894
Bonding		1,539,894										1,539,894
Middle School HVAC	BOE-04			300,000		3,782,228						4,082,228
Bonding				300,000		3,782,228						4,082,228
Head O'Meadow - Boiler Plant	BOE-05			425,000								425,000
Bonding				425,000								425,000
Head O'Meadow - Lighting	BOE-05B	425,000										425,000
Bonding		425,000										425,000
Hawley - New Generator	BOE-06	250,000										250,000
Bonding		250,000										250,000
Middle Gate - Window Modifications	BOE-07						1,000,000					1,000,000
Bonding							1,000,000					1,000,000
High School - Turf Practice Field (rear of school)	BOE-08						1,100,000					1,100,000
Bonding							1,100,000					1,100,000
Hawley - Elevator to Café	BOE-09						318,000					318,000
Bonding							318,000					318,000
Reed - New Roof, Solar panels remove and reinstall	BOE-10						3,710,000					3,710,000
Bonding							3,710,000					3,710,000
Middle School - Complete Kitchen Renovation	BOE-11						795,000					795,000
Bonding							795,000					795,000
High School - New Roof / Restoration	BOE-12						2,921,360					2,921,360
Bonding							2,921,360					2,921,360
High School - Rear Field Facilities and Storage	BOE-13						954,000					954,000

Department	Project #	'21/'22	'22/'23	'23/'24	'24/'25	'25/'26	'26/'27	'27/'28	'28/'29	'29/'30	'30/'31	Total
<i>Bonding</i>							954,000					954,000
Hawley - Classroom Renovations '21 section	BOE-14							1,011,240				1,011,240
<i>Bonding</i>								1,011,240				1,011,240
Middle Gate - Pave Parking Lot, Curbing, Sidewalks	BOE-15							1,378,000				1,378,000
<i>Bonding</i>								1,378,000				1,378,000
Head O'Meadow - New Roofing / Restoration	BOE-16							2,696,640				2,696,640
<i>Bonding</i>								2,696,640				2,696,640
Reed - Repave Parking Lot, Curbing, Sidewalks	BOE-17							2,120,000				2,120,000
<i>Bonding</i>								2,120,000				2,120,000
Middle School - Library & Science Lab Renovations	BOE-18							3,710,000				3,710,000
<i>Bonding</i>								3,710,000				3,710,000
High School - Athletic/Stadium Field House & Store	BOE-19							1,685,400				1,685,400
<i>Bonding</i>								1,685,400				1,685,400
Hawley - Repave Parking Lot, Curbing, Sidewalks	BOE-20								1,378,000			1,378,000
<i>Bonding</i>									1,378,000			1,378,000
Middle Gate - Complete Kitchen Renovation	BOE-21								397,500			397,500
<i>Bonding</i>									397,500			397,500
Head O'Meadow - Replace / Update A/C	BOE-22								6,179,800			6,179,800
<i>Bonding</i>									6,179,800			6,179,800
Middle School - Parking Lot, Curbing, Sidewalks	BOE-23								1,685,400			1,685,400
<i>Bonding</i>									1,685,400			1,685,400
Middle Gate - Ventilation, HVAC Renovations	BOE-24										300,000	300,000
<i>Bonding</i>											300,000	300,000
Middle School - Window Replacements	BOE-25										1,000,000	1,000,000
<i>Bonding</i>											1,000,000	1,000,000
High School - HVAC Equipment Replacements	BOE-26										5,300,000	5,300,000
<i>Bonding</i>											5,300,000	5,300,000
Board of Education Total		4,509,894	2,500,000	4,725,000		3,782,228	10,798,360	12,601,280	9,640,700		6,600,000	55,157,462
Economic Development												
Clean up of 7 & 28A Glen Road	EDC - 1	200,000										200,000
<i>Bonding</i>		200,000										200,000
Clean up of 28A Glen Road	EDC - 1a		650,000									650,000

Department	Project #	'21/'22	'22/'23	'23/'24	'24/'25	'25/'26	'26/'27	'27/'28	'28/'29	'29/'30	'30/'31	Total
<i>Bonding</i>			650,000									650,000
Town Match - Grants (contingency)	EDC - 2	200,000	200,000	200,000	200,000	200,000	200,000	200,000	200,000	200,000	200,000	2,000,000
<i>Other</i>		200,000	200,000	200,000	200,000	200,000	200,000	200,000	200,000	200,000	200,000	2,000,000
Economic Development Total		400,000	850,000	200,000	200,000	200,000	200,000	200,000	200,000	200,000	200,000	2,850,000
Edmond Town Hall												
Edmond Town Hall - Parking Lot Improvements	ETH - 1		450,000									450,000
<i>Bonding</i>			450,000									450,000
Edmond Town Hall Building Renovations	ETH - 2					550,000						550,000
<i>Bonding</i>						550,000						550,000
ETH Space Revitalization/Elevator Removal	ETH - 3						550,000					550,000
<i>Bonding</i>							550,000					550,000
ETH plumbing/radiator renewal/LC access	ETH - 4								500,000			500,000
<i>Bonding</i>									500,000			500,000
Edmond Town Hall Total			450,000			550,000		550,000	500,000			2,050,000
Emergency Comm Ctr												
Emergency Radio System Upgrades	ECC - 1	5,041,933										5,041,933
<i>Bonding</i>		5,041,933										5,041,933
Emergency Comm Ctr Total		5,041,933										5,041,933
FHA												
Building remediation & demo/infrastructure	FHA-1		2,000,000	1,500,000		2,000,000	2,000,000	3,000,000				10,500,000
<i>Bonding</i>			2,000,000	1,500,000		2,000,000	2,000,000	3,000,000				10,500,000
FHA Total			2,000,000	1,500,000		2,000,000	2,000,000	3,000,000				10,500,000
Fire												
Replacement of Fire Apparatus	Fire - 1		450,000	1,035,000		750,000	770,000	790,000				3,795,000
<i>Bonding</i>			450,000	800,000		750,000	770,000	790,000				3,560,000
<i>Other</i>				235,000								235,000
New Generators and Transfer Switches	Fire - 2								240,000			240,000
<i>Bonding</i>									240,000			240,000
Dodgingtown Fire House Renovations	Fire - 3									475,000		475,000
<i>Bonding</i>										475,000		475,000
Fire Total			450,000	1,035,000		750,000	770,000	790,000	240,000	475,000		4,510,000

Department	Project #	'21/'22	'22/'23	'23/'24	'24/'25	'25/'26	'26/'27	'27/'28	'28/'29	'29/'30	'30/'31	Total
Library												
Library Building & Grounds Upgrades/Reno/Expansion	LIB-1	200,000	550,000	1,046,000		1,000,000		450,000				3,246,000
Bonding		200,000	550,000	1,046,000		1,000,000		450,000				3,246,000
Library Total		200,000	550,000	1,046,000		1,000,000		450,000				3,246,000
Parks & Recreation												
Treadwell Artificial Turf & Lighting Replacement	P & R - 1					800,000						800,000
Bonding						250,000						250,000
Other						550,000						550,000
Rail Trail - Batchelder Park	P & R - 2					1,400,000						1,400,000
Grants						1,400,000						1,400,000
Lake Lillinonah Park Improvements	P & R - 3			500,000								500,000
Other				500,000								500,000
Parks & Recreation Total				500,000		2,200,000						2,700,000
Public Works												
Capital Road Program	PW - 1	3,000,000	3,000,000	3,050,000	3,100,000	3,150,000	3,200,000	3,250,000	3,300,000	3,350,000	3,400,000	31,800,000
Bonding		500,000	250,000									750,000
General Fund		2,500,000	2,750,000	3,050,000	3,100,000	3,150,000	3,200,000	3,250,000	3,300,000	3,350,000	3,400,000	31,050,000
Bridge Replacement Program	PW - 2		400,000	400,000		400,000	400,000	400,000	400,000	400,000		2,800,000
Bonding			400,000	400,000		400,000	400,000	400,000	400,000	400,000		2,800,000
Multi-Purpose Building Electrical/Mechanical/HVAC	PW - 3			413,000								413,000
Bonding				413,000								413,000
Municipal Center - Roof Remediation & Replacement	PW - 4			1,000,000								1,000,000
Bonding				1,000,000								1,000,000
Truck Washing Station	PW - 5						550,000					550,000
Bonding							550,000					550,000
Public Works Site & Salt Storage Improvements	PW - 6						600,000					600,000
Bonding							600,000					600,000
Transfer Station Improvements	PW - 7						400,000					400,000
Bonding							400,000					400,000
Public Works Total		3,000,000	3,400,000	4,863,000	3,100,000	3,550,000	5,150,000	3,650,000	3,700,000	3,750,000	3,400,000	37,563,000
S.H. Permanent Memorial Comm												
Sandy Hook Permanent Memorial	FS - 1	2,000,000	2,000,000									4,000,000
Bonding		2,000,000	2,000,000									4,000,000

Department	Project #	'21/'22	'22/'23	'23/'24	'24/'25	'25/'26	'26/'27	'27/'28	'28/'29	'29/'30	'30/'31	Total
S.H. Permanent Memorial Comm Total		2,000,000	2,000,000									4,000,000
Water & Sewer Authority												
Fairfield Hills Water Infrastructure	226						750,000					750,000
Other							750,000					750,000
Water & Sewer Authority Total							750,000					750,000
GRAND TOTAL		15,151,827	12,200,000	13,869,000	3,300,000	14,032,228	19,668,360	21,241,280	14,280,700	4,425,000	10,200,000	128,368,395

Town of Newtown, Connecticut

Capital Improvement Plan

'21/'22 thru '25/'26

EXPENDITURES AND SOURCES SUMMARY

Department	'21/'22	'22/'23	'23/'24	'24/'25	'25/'26	Total
Board of Education	4,509,894	2,500,000	4,725,000		3,782,228	15,517,122
Economic Development	400,000	850,000	200,000	200,000	200,000	1,850,000
Edmond Town Hall		450,000			550,000	1,000,000
Emergency Comm Ctr	5,041,933					5,041,933
FHA		2,000,000	1,500,000		2,000,000	5,500,000
Fire		450,000	1,035,000		750,000	2,235,000
Library	200,000	550,000	1,046,000		1,000,000	2,796,000
Parks & Recreation			500,000		2,200,000	2,700,000
Public Works	3,000,000	3,400,000	4,863,000	3,100,000	3,550,000	17,913,000
S.H. Permanent Memorial Comm	2,000,000	2,000,000				4,000,000
EXPENDITURE TOTAL	15,151,827	12,200,000	13,869,000	3,300,000	14,032,228	58,553,055

Source	'21/'22	'22/'23	'23/'24	'24/'25	'25/'26	Total
Bonding	12,451,827	9,250,000	9,884,000		8,732,228	40,318,055
General Fund	2,500,000	2,750,000	3,050,000	3,100,000	3,150,000	14,550,000
Grants					1,400,000	1,400,000
Other	200,000	200,000	935,000	200,000	750,000	2,285,000
SOURCE TOTAL	15,151,827	12,200,000	13,869,000	3,300,000	14,032,228	58,553,055

Bonding approved in current approved CIP	13,203,933	8,287,730	8,678,812	-0-	N/A	30,170,475
						not including 25/26
Difference in bonding amounts	(752,106)	962,270	1,205,188	-0-	N/A	1,415,352

FIVE YEAR PROJECT DETAIL
2021-22 TO 2025-26

Capital Improvement Plan

Town of Newtown, Connecticut

'21/'22 thru '25/'26

Project # **BOE-01**
Project Name **Hawley - Ventilation and HVAC**

Type Building construction/renovation Department Board of Education
Useful Life 35 Contact TANYA VADAS
Category Buildings

Description

This project will allow installation of a complete ventilation system to service the entire building. Project will include HVAC units, ductwork, controls, electrical upgrades, and other related work.

Justification

This will improve the air quality of the building by providing heating, cooling, and ventilation for the students, staff, and faculty. Due to proximity of Church Hill Rd, opening windows leads to traffic noise and poor air quality from vehicle exhaust.

Expenditures	Prior	'21/'22	'22/'23	'23/'24	'24/'25	'25/'26	Future	Total
Planning/Design	300,000							300,000
Construction/Maintenance		1,500,000	2,500,000	4,000,000				8,000,000
Total	300,000	1,500,000	2,500,000	4,000,000				8,300,000

Funding Sources	Prior	'21/'22	'22/'23	'23/'24	'24/'25	'25/'26	Future	Total
Bonding		1,500,000	2,500,000	4,000,000				8,000,000
Other	300,000							300,000
Total	300,000	1,500,000	2,500,000	4,000,000				8,300,000

Budget Impact/Other

Adding air conditioning will inevitably increase electricity costs to power the new equipment.
Average annual debt service = \$288,000.

---EXCERPT---

Hawley Elementary School
Newtown, CT
HVAC Upgrade

Conceptual Estimate

20-Nov-20

Prepared by:
MEP Cost LLC

For:
Christopher Williams Architects, LLC



Hawley Elementary School
Newtown, CT
HVAC Upgrade

Conceptual Estimate

Gross Floor Area (sf): 54,193
Date: 20-Nov-20

Basis of Estimate

Net Floor Area:

Phase 1 - Area C - 1921 Building	16,298	sf
Phase 2 - Area B (& 1997 classrooms) - 1948 Addition	25,710	sf
Phase 3 - Area A - 1997 Addition	12,185	sf
TOTAL	54,193	sf
 1921 Building Attic	 4,773	 sf

Information used in preparation of estimate:

Basis of Design Narrative Draft Report dated Oct. 24, 2020 by BVH Integrated Services
Photos of existing conditions provided by Christopher Williams Architects LLC
2012 Boiler Replacement project drawings
2005 HVAC Repairs drawings
Information received through emails, and in telephone discussions with BVH and CWA



**Hawley Elementary School
Newtown, CT
HVAC Upgrade**

Conceptual Estimate

Gross Floor Area (sf): 54,193
Date: 20-Nov-20

Clarifications & Exclusions

Clarifications:

The estimated construction durations are:

- Phase 1: 5 months for work in the 1921 building/Area C.
- Phase 2: 5 months for work in the 1948 addition/Area B.
- Phase 3: 2 months for work in the 1997 addition/Area A.

The estimated construction start dates are:

- June, 2021 for the 1921 building/Area C.
- June, 2022 for the 1948 addition/Area B.
- As desired for the 1997 addition/Area A.

As construction is desired to be phased and possibly performed during summer and other breaks, the estimate includes a 10% phasing premium, to account for multiple mobilizations/demobilizations, possible double shift premiums, possible night and weekend work premiums, temporary services/connections/reconnections, premiums for smaller work packages, etc.

This estimate is based on the use of a VAV reheat (variable air volume) HVAC system.

The estimate is based on prevailing wage rates for construction in this market, and represents a reasonable opinion of cost. It is not a prediction of the successful low bid from a contractor as bids will vary due to fluctuating market conditions, errors and omissions, proprietary specifications, a lack of or surplus of bidders, perception of risk, etc. Consequently the estimate is expected to fall within the range of bids from a number of competitive contractors or subcontractors.

Exclusions:

Costs associated with the following items are **NOT** included in the estimate:

- code upgrades (eg: building, seismic, fire alarm, fire protection, life safety, etc).
- firesafing of any existing penetrations.
- roof warranty extension (after repairs/patching for HVAC upgrade work).
- state sales tax.
- soft costs (design fees, bldg permits, etc).



Hawley Elementary School
Newtown, CT
HVAC Upgrade

Conceptual Estimate

Gross Floor Area (sf): 54,193
Date: 20-Nov-20

EXECUTIVE SUMMARY

Total

Phase 1 (Area C) - 1921 Building	\$	3,435,245
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Phase 2 (Area B) - 1948 Addition (+ 1997 Classrooms)	\$	3,001,220
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Phase 3 (Area A) - 1997 Addition	\$	832,072
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TOTAL - All Phases	\$	7,268,537
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Hawley School Meeting PBSC Meeting Agenda

Meeting Date **November 24, 2020**

CWA TEAM:

Christopher Williams CWA

Ilona Prosol, BVH

John Luby, Enviro-med.

1. **Testing:** Enviro-med is scheduled to perform the second IAQ study on the week of December 7, 2020, which is a postponement from the scheduled date due to distance learning.
2. **Meeting Notes, 11/3/20:** On 11/03/20, a zoom meeting was held with:
 - Bob Gerbert (Town of Newtown)
 - Allen Adriani (Town of Newtown)
 - Christopher Williams (CWA)
 - Ilona Prosol (BVH)
 - Jeremy Rapoza (BVH)
 - Josiah Butler (BVH)
- 2.1. Items discussed:
 - 2.1.1. The Town is concerned that the VRF system will result in a series of individual units throughout the building that rely on a refrigerant that will be phased out of production in 2024, resulting in excessive refrigerant replenishment costs afterwards and possible complicated replacement work when the units become obsolete in the future.
 - 2.1.2. Design parameters were reviewed, and it was agreed that equipment should be sized per ASHRAE/IMC ventilation rates.
 - 2.1.3. The increase in ductwork size will necessitate additional suspended ceiling modifications and/or additions. The Town agreed, especially in the 1921 building that has high ceilings with poor acoustics.
 - 2.1.4. The Town reiterated the preference to design a VAV type system.
 - 2.1.5. The Town requested that a conceptual estimate be prepared by 11/6/20 for the next finance committee meeting.
3. **Conceptual Estimate no. 1, 11/6/20:**
 - 3.1. 11/6/20 Estimate: CWA presented an estimate totaling \$6,313,595.00. This was based on a VRF system proposed by BVH. An additional Rough Order of Magnitude (ROM) cost of \$1,000,00 was identified to upgrade the system to a VAV system. The additional costs would be attributed to:
 - 3.1.1. Larger ductwork required to handle the increased volume of air.
 - 3.1.2. Changing refrigerant piping to hot water supply and return piping.
 - 3.1.3. Increase in spatial requirements to accommodate larger ductwork and VAV units throughout the building.
 - 3.1.4. Increase in outdoor air, resulting in additional louvers.
 - 3.1.5. Additional suspended ceilings being removed/replaced and added throughout the building.
4. **Meeting Notes, 11/13/20:** On 11/03/20, a zoom meeting was held with:
 - Bob Gerbert (Town of Newtown)
 - Allen Adriani (Town of Newtown)



CHRISTOPHER WILLIAMS ARCHITECTS LLC

Gordon Johnson (Town of Newtown)
Christopher Williams (CWA)
Ilona Prosol (BVH)
Jeremy Rapoza (BVH)

4.1. Items Discussed:

- 4.1.1. Budget: The \$6.3 - \$7.3 million estimate exceeds the Town's initial \$4.1 Million estimate.
- 4.1.2. The Town will consider phasing the project into three phases roughly reflecting the vintage of each building wing-1921, 1948 and 1997.
- 4.1.3. The design team expressed concern over phasing and performing the work during school breaks, which would be 2 months during the summer and a few weeks during the school year. The work cannot reasonably be completed in those time periods, especially if a more extensive ducted system is deployed. The town needs to develop temporary plans for the classes held in the affected rooms.
- 4.1.4. The design team recommends that the Town engage a Construction Manager/Owner's Rep who can assist in developing logistic plans, identify swing spaces, develop independent cost estimates and offer funding/budgeting guidance on ancillary but necessary non-construction expenses.
- 4.1.5. The design team was asked to develop a phased Conceptual Estimate by 11/20/20.

5. Conceptual Estimate no. 2, 11/20/20:

- 5.1. The attached Conceptual Estimate is divided into 3 phases totaling \$7,268,537.00.
- 5.2. In addition to the estimate, attached are phasing floor plans:
 - 5.2.1. Phase 1: 1921 Building
 - 5.2.2. Phase 2: 1948 Building and part of the 1995 Building. The central corridor of the 1948 building extends into the 1995 building and including it with the 1948 building is a logical choice. The 1995 lobby/corridor that extends beyond the classrooms would not be included in phase 2, so corridor bi-directional doors may be considered to keep the atmospheres separate.
 - 5.2.3. Phase 3: Replacing/upgrading the 1995 building Rooftop units, including extending the system into Science Classroom M100 and the lobby/corridor.

6. Design Progress: The design team has developed progress plans sufficient for the cost estimator to develop the attached budget. Between actual drawings, take-offs from the BIM model, narratives and discussions, the scope is sufficiently captured in the budget. As with most conceptual budgets, some items may be high in cost and some low but will level off as the accuracy of design and pricing increases.

- 6.1. To move forward into Design Development, the design team needs direction on the budget from the Town.

Attachments as Separate Files:

Conceptual Estimate, dated 20-Nov-20 prepared by MEP Cost LLC
G001-Phasing Plans-dated 11.20.20 prepared by CWA
Progress Drawing Set-dated 11.20.20 by CWA and BVH

Hawley Elementary School
HVAC Improvements

- Split project into separate phases
 - Phase I – 1921 Section
 - Phase II – 1948 Section
- Phase I work scope
 - Perform work using current funding on CIP
 - Ducted VAV air distribution for 1921 portion of building
 - Electrical service upgrade to facilitate Phase I and Phase II work
 - Ceiling/lighting in classrooms, hallways, etc.
 - HVAC controls
- Phase II work scope
 - Add project/funding to CIP in 2021 for FY 2024/25
 - Ducted VAV air distribution for 1948 portion of building
 - Ceiling/lighting in classrooms, hallways, etc.
- Phase I work split into two summers 2021 & 2022

Summer 2021

- Electric service upgrade
- Hazmat abatement
- HVAC unit prep work (i.e equipment pads)
- Structural modifications/prep work
- Roofing modification/prep work

Summer 2022

- HVAC unit installation
- Ductwork/VAV installation
- Heating pipe installation
- Ceiling/lighting installation


-Phase II work

Summer 2023


- HVAC unit prep work (roof curbs)
- Structural modifications/prep work
- Roofing modifications/prep work
- Hazmat abatement

Summer 2024

- HVAC unit installation
- Ductwork/VAV installation
- Heating pipe installation
- Ceiling/lighting installation

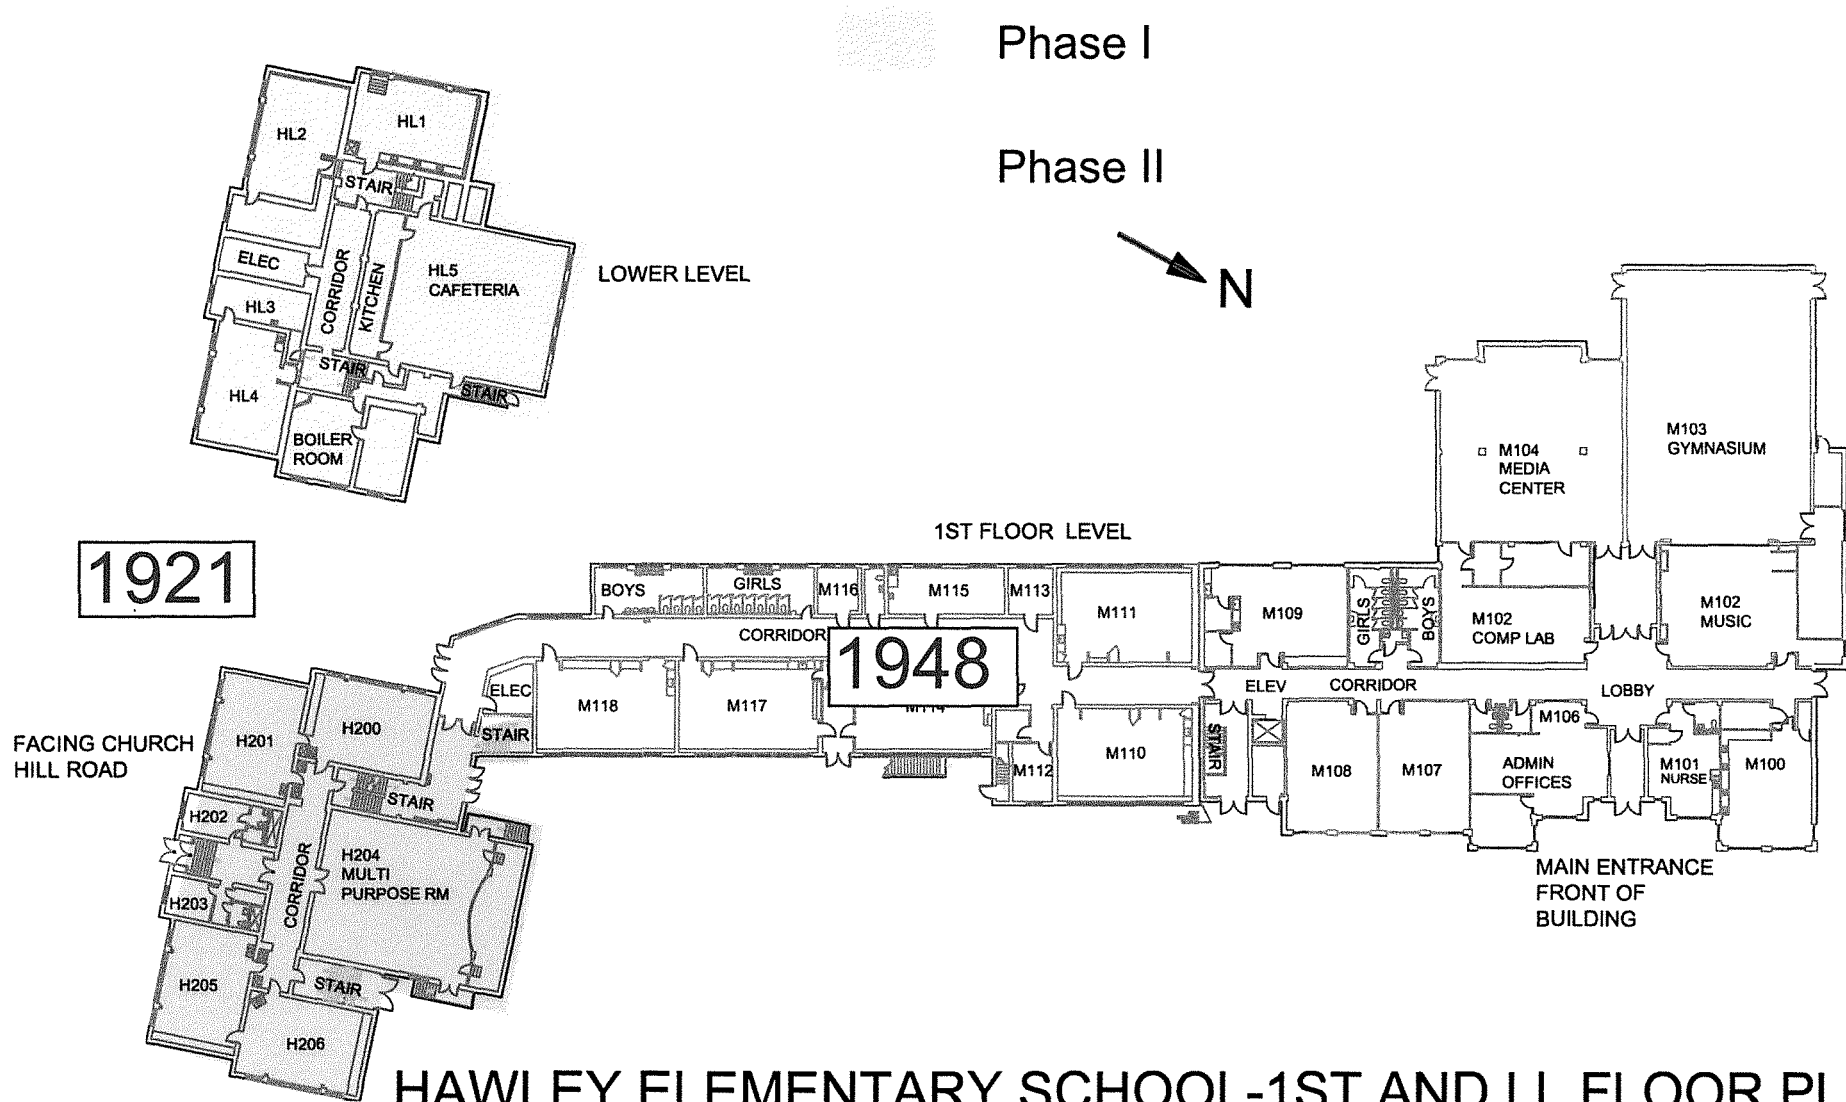

HAWLEY ELEMENTARY SCHOOL-1ST AND LL FLOOR PLAN

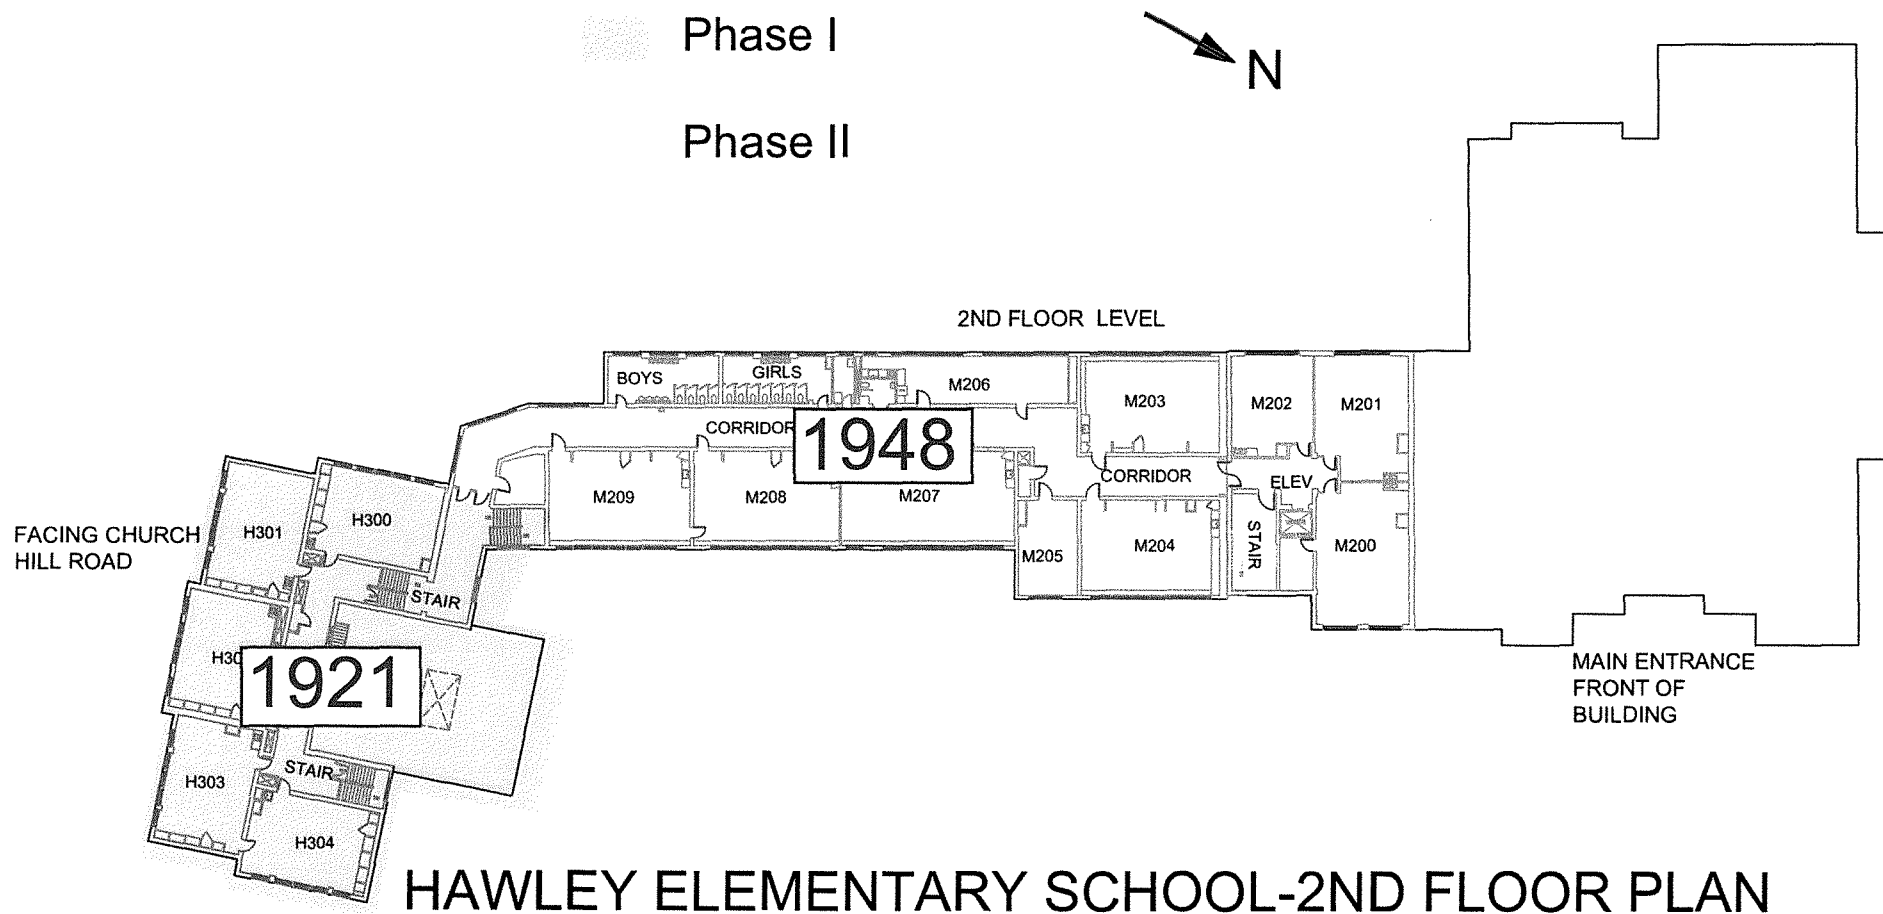

HAWLEY ELEMENTARY SCHOOL-2ND FLOOR PLAN

Capital Improvement Plan

Town of Newtown, Connecticut

'21/'22 *thru* '25/'26

Project # **BOE-02**
 Project Name **High School - Replace / Restore Stadium Turf**

Type Land Improvements Department Board of Education
 Useful Life 10 Contact TANYA VADAS
 Category Land Improvements

Description

This project will replace the turf field and track for the High School stadium. Current turf is 11 years old and is approaching the end of its useful life.

Justification

Turf and track will be at the end of its useful life in 21/22 and is a potential safety issue.

Expenditures	Prior	'21/'22	'22/'23	'23/'24	'24/'25	'25/'26	Future	Total
Construction/Maintenance		795,000						795,000
Total		795,000						795,000

Funding Sources	Prior	'21/'22	'22/'23	'23/'24	'24/'25	'25/'26	Future	Total
Bonding		795,000						795,000
Total		795,000						795,000

Budget Impact/Other

Negligible impact as the new turf and track will require the same ongoing maintenance as existing turf and track.
 Average annual debt service = \$50,500.

Capital Improvement Plan

Town of Newtown, Connecticut

'21/'22 thru '25/'26

Project # BOE-03
Project Name Reed - Install Gas Boiler / LED Lighting

Type Equipment Purchases
Useful Life
Category Equipment
Department Board of Education
Contact TANYA VADAS

Description

This project will include replacement of existing boilers with new high-efficiency condensing boilers and upgrade of all building light fixtures to LED. This qualifies for utility rebates offered from Eversource. Project will include boilers, pumps, VFDs, and LED lighting.

Justification

Existing boilers are approaching their useful life. New boilers will improve energy efficiency. New lighting will also improve energy efficiency.

Expenditures	Prior	'21/'22	'22/'23	'23/'24	'24/'25	'25/'26	Future	Total
Construction/Maintenance		1,539,894						1,539,894
Total		1,539,894						1,539,894

Funding Sources	Prior	'21/'22	'22/'23	'23/'24	'24/'25	'25/'26	Future	Total
Bonding		1,539,894						1,539,894
Total		1,539,894						1,539,894

Budget Impact/Other

Condensing gas boilers will offer savings from reduced natural gas consumption. LED lights will reduce electricity costs due to greater efficiency and also result in less maintenance.
Average annual debt service = \$98,000 (without considering the energy rebate)

Capital Improvement Plan

Town of Newtown, Connecticut

'21/'22 thru '25/'26

Project # BOE-04
Project Name Middle School HVAC

Type Building construction/renovation
Useful Life 20
Category Buildings
Department Board of Education
Contact TANYA VADAS

Description

This project will include the installation of ducted ventilation systems, replacement of existing HVAC units, and installation of new HVAC to key areas of the building (i.e. Auditorium, Cafeteria).

Justification

New HVAC units and ventilation system will improve indoor air quality. Existing HVAC units have exceeded their useful life.

Expenditures	Prior	'21/'22	'22/'23	'23/'24	'24/'25	'25/'26	Future	Total
Planning/Design				300,000				300,000
Construction/Maintenance						3,782,228		3,782,228
Total				300,000		3,782,228		4,082,228

Funding Sources	Prior	'21/'22	'22/'23	'23/'24	'24/'25	'25/'26	Future	Total
Bonding				300,000		3,782,228		4,082,228
Total				300,000		3,782,228		4,082,228

Budget Impact/Other

Replacement of existing HVAC units should reduce electricity and maintenance costs as new equipment is more energy efficient and not require persistent repairs.
Average annual debt service = \$261,000.

Capital Improvement Plan

Town of Newtown, Connecticut

'21/'22 *thru* '25/'26

Project # **BOE-05**
Project Name **Head O'Meadow - Boiler Plant**

Type Building construction/renovation Department Board of Education
Useful Life 20 Contact
Category Buildings

Description

This project will include the replacement of existing heating equipment in the boiler plant to include boilers, pumps, VFDs, and water heaters.

Justification

The controls, drives and pumps are old technology and inefficient.

Expenditures	Prior	'21/'22	'22/'23	'23/'24	'24/'25	'25/'26	Future	Total
Construction/Maintenance				425,000				425,000
Total				425,000				425,000

Funding Sources	Prior	'21/'22	'22/'23	'23/'24	'24/'25	'25/'26	Future	Total
Bonding				425,000				425,000
Total				425,000				425,000

Budget Impact/Other

Average annual debt service = \$33,000

Capital Improvement Plan

Town of Newtown, Connecticut

'21/'22 *thru* '25/'26

Project # **BOE-05B**
 Project Name **Head O'Meadow - Lighting**

Type Building construction/renovation Department Board of Education
 Useful Life Contact
 Category Equipment

Description

Light fixtures throughout the building will be upgrade to LED.

Justification

A complete retrofit of all existing lighting from fluorescent to LED will ensure continued operation and a tremendous financial and energy savings.

Expenditures	Prior	'21/'22	'22/'23	'23/'24	'24/'25	'25/'26	Future	Total
Construction/Maintenance		425,000						425,000
Total		425,000						425,000

Funding Sources	Prior	'21/'22	'22/'23	'23/'24	'24/'25	'25/'26	Future	Total
Bonding		425,000						425,000
Total		425,000						425,000

Budget Impact/Other

Average annual debt service = \$33,000

Capital Improvement Plan

Town of Newtown, Connecticut

'21/'22 *thru* '25/'26

Project # **BOE-06**
Project Name **Hawley - New Generator**

Type Equipment Purchases
Useful Life 10
Category Equipment

Department Board of Education
Contact TANYA VADAS

Description

This project will install an emergency generator at the Hawley school

Justification

This is currently the only school without a generator.

Expenditures	Prior	'21/'22	'22/'23	'23/'24	'24/'25	'25/'26	Future	Total
Equip/Vehicles/Furnishings		250,000						250,000
Total		250,000						250,000

Funding Sources	Prior	'21/'22	'22/'23	'23/'24	'24/'25	'25/'26	Future	Total
Bonding		250,000						250,000
Total		250,000						250,000

Budget Impact/Other

There would be a modest increase in fuel to operate the generator.
Average annual debt service amount = \$67,000

Capital Improvement Plan

Town of Newtown, Connecticut

'21/'22 *thru* '25/'26

Project # **EDC - 1**
Project Name **Clean up of 7 & 28A Glen Road**

Type Land Improvements
Useful Life 50
Category Land Improvements

Department Economic Development
Contact Christal Preszler, Deputy Dir, Eco

Description

7 Glen Road and 28A Glen Road - Cleanup, oversight and assessment/removal of miscellaneous hazardous and non-hazardous materials on these and other town owned properties.

Justification

Clean up town property to remove blight and improve safety, with the goal of eventually getting onto the tax rolls.

Expenditures	Prior	'21/'22	'22/'23	'23/'24	'24/'25	'25/'26	Future	Total
Other		200,000						200,000
Total		200,000						200,000

Funding Sources	Prior	'21/'22	'22/'23	'23/'24	'24/'25	'25/'26	Future	Total
Bonding		200,000						200,000
Total		200,000						200,000

Capital Improvement Plan

Town of Newtown, Connecticut

'21/'22 thru '25/'26

Project # **EDC - 1a**
Project Name **Clean up of 28A Glen Road**

Type Land Improvements
Useful Life 50
Category Land Improvements

Department Economic Development
Contact Christal Preszler, Deputy Dir, Eco

Description

28A Glen Road is located in the heart of Sandy Hook Village. The property, obtained by the town via tax foreclosure, contains multiple structures. Remediation of hazardous materials is necessary in both structures and soil. Demolition cost of structures is also included in this estimate. As with most remediation projects, the Hazardous Building Materials Assessment and Phase I and Phase II reports are the basis of project cost estimates. In this situation, the reports named high and low cost estimates. The money being requested here is an average of the high and low estimates, less the \$200,000 for Project # EDC - 1 in '21 - '22.

Justification

Expenditures	Prior	'21/'22	'22/'23	'23/'24	'24/'25	'25/'26	Future	Total
Other			650,000					650,000
Total			650,000					650,000

Funding Sources	Prior	'21/'22	'22/'23	'23/'24	'24/'25	'25/'26	Future	Total
Bonding			650,000					650,000
Total			650,000					650,000

Budget Impact/Other

As with most remediation projects, the Hazardous Building Materials Assessment and Phase I and Phase II reports are the basis of project cost estimates. In this situation, the reports named high and low cost estimates. The money being requested here is an average of the high and low estimates, less the \$200,000 for Project # EDC - 1 in '21 - '22.

Capital Improvement Plan

Town of Newtown, Connecticut

'21/'22 thru '25/'26

Project # **EDC - 2**
 Project Name **Town Match - Grants (contingency)**

Type Unassigned
 Useful Life
 Category Unassigned

Department Economic Development
 Contact Christal Preszler, Deputy Dir, Eco

Description

EDC is continually looking for grants to remediate buildings, soil and support economic development in town. Most grants will include a town match. The amounts reflected are contingencies.

Justification

Need to demonstrate the towns commitment to match grants.

Expenditures	Prior	'21/'22	'22/'23	'23/'24	'24/'25	'25/'26	Future	Total
Other		200,000	200,000	200,000	200,000	200,000	1,000,000	2,000,000
Total		200,000	200,000	200,000	200,000	200,000	1,000,000	2,000,000

Funding Sources	Prior	'21/'22	'22/'23	'23/'24	'24/'25	'25/'26	Future	Total
Other		200,000	200,000	200,000	200,000	200,000	1,000,000	2,000,000
Total		200,000	200,000	200,000	200,000	200,000	1,000,000	2,000,000

Budget Impact/Other

Annual debt service amount = \$13,500 (for each \$200,000)

Capital Improvement Plan

Town of Newtown, Connecticut

'21/'22 thru '25/'26

Project # **ETH - 1**
 Project Name **Edmond Town Hall - Parking Lot Improvements**

Type Land Improvements
 Useful Life 25
 Category Land Improvements

Department Edmond Town Hall
 Contact Margot S. Hall, Chairman

Description

Repair current parking lot to provide safe, well lit space for parking and security cameras for users and events. Install lighting, cameras and improve use and maintenance by providing access to water and power. Improve pedestrian walkways, traffic pattern, signage, additional spaces, including handicapped parking, better grading. Demolish firehouse but keep lean to if possible for dumpster enclosure. Increase parking spaces, both regular and handicapped. Provide parking spaces marked with letters for sections to make directing parking easier. Install security cameras at entrance, exits and in rear of lot especially. Provide a water source and heavy duty electric outlets for maintenance and events. Provide maintenance-free landscaping on the hilly areas to improve visibility and safety. Provide improved signage for cars and pedestrians. Install rumble strips on entry and exit driveways to slow down cars entering and exiting. Improve grading near handicap entry to avoid ice build ups. Increase number of handicap spaces as close to building as possible. Add small cement ramp to the south side door step and a push button to enable handicapped to use that entrance. Provide clearly marked pedestrian walkways. Install maintenance-free landscaping around perimeter, hilly areas and border to improve security.

Justification

Current parking lot has old patched pavement covering hollow areas that can collapse underfoot. Lot use in greater demand not only by patrons, but also large commercial vehicles including Town, Eversource, vendors and others. Traffic pattern was based on firehouse needs, which are no longer necessary. Lot needs improved signage, delineated walkways, better use physically impaired building users.

Expenditures	Prior	'21/'22	'22/'23	'23/'24	'24/'25	'25/'26	Future	Total
Construction/Maintenance			450,000					450,000
Total			450,000					450,000

Funding Sources	Prior	'21/'22	'22/'23	'23/'24	'24/'25	'25/'26	Future	Total
Bonding			450,000					450,000
Total			450,000					450,000

Budget Impact/Other

Average annual debt service amount = \$30,400.

Capital Improvement Plan

Town of Newtown, Connecticut

'21/'22 thru '25/'26

Project # **ETH - 2**
Project Name **Edmond Town Hall Building Renovations**

Type Building construction/renovation Department Edmond Town Hall
Useful Life 35 Contact Margot S. Hall, Chairman
Category Buildings

Description

Install kitchennette under stairs in gym with sink, undercounter ice maker, large refrigerator. This locks when not in use. Tall warming ovens. Components are individual and easy to repair/replace. Replace toilets and sinks. Install removable platform for concerts, special events. Renovate storage closet for ease of use by renters and staff when storing care equipment. Install blinds that can be changed remotely to cover all windows as needed based on event. Install retractable screen for presentations. Install large AC window units in the space that used to house the ventilators. This would be for use during very hot days. Install speakers/P.A. system for events and sports.

Justification

As the most revenue-generating rental, the gym needs to be revitalized in order to keep this 5000 square foot space attractive to renters and to expand its use. It can serve the community much better with a few key adds.

Expenditures	Prior	'21/'22	'22/'23	'23/'24	'24/'25	'25/'26	Future	Total
Construction/Maintenance						550,000		550,000
Total						550,000		550,000

Funding Sources	Prior	'21/'22	'22/'23	'23/'24	'24/'25	'25/'26	Future	Total
Bonding						550,000		550,000
Total						550,000		550,000

Budget Impact/Other

Less maintenance expenses and additional revenue.

Capital Improvement Plan

Town of Newtown, Connecticut

'21/'22 thru '25/'26

Project # **ECC - 1**
Project Name **Emergency Radio System Upgrades**

Type Equipment Purchases
Useful Life 10
Category Equipment
Department Emergency Comm Ctr
Contact Maureen Will, ECC Director

Description

The current Newtown Public Safety communications systems are no longer supported and are at "end of life". This system replacement is critical to ensure first responders are dispatched and supported in the field while performing their duties in support of the residents of Newtown. See attached report.

Note: Total CIP amount is \$7,541,933 (over two years - 2020-21 & 2021-22). A bonding resolution was approved for \$2,500,000 on 5/6/2020.

Justification

Equipment have reached their useful life

Expenditures	Prior	'21/'22	'22/'23	'23/'24	'24/'25	'25/'26	Future	Total
Other	2,500,000	5,041,933						7,541,933
Total	2,500,000	5,041,933						7,541,933

Funding Sources	Prior	'21/'22	'22/'23	'23/'24	'24/'25	'25/'26	Future	Total
Bonding	2,500,000	5,041,933						7,541,933
Total	2,500,000	5,041,933						7,541,933

Budget Impact/Other

Average annual debt service for total project = \$510,000. Maintenance agreement will increase in cost ("life cycle planning")

Capital Improvement Plan

Town of Newtown, Connecticut

'21/'22 *thru* '25/'26

Project # **FHA-1**
 Project Name **Building remediation & demo/infrastructure**

Type Land Improvements
 Useful Life
 Category Buildings

Department FHA
 Contact

Description

Activities in support of building assessment; mothballing; safety enhancements; renovation; remediation; demolition & campus infrastructure (Ex: Water distribution upgrades).
 Possible projects: Infrastructure - \$750,000; Norwalk - \$1,000,000; Stamford - \$1,000,000; Shelton - \$1,800,000; Duplex mothball - \$608,000; Newtown Hall mothball - \$821,000; Cochran remediation - \$679,000, Kent - \$4,000,000, etc.

Justification

Expenditures	Prior	'21/'22	'22/'23	'23/'24	'24/'25	'25/'26	Future	Total
Other			2,000,000	1,500,000		2,000,000	5,000,000	10,500,000
Total			2,000,000	1,500,000		2,000,000	5,000,000	10,500,000

Funding Sources	Prior	'21/'22	'22/'23	'23/'24	'24/'25	'25/'26	Future	Total
Bonding			2,000,000	1,500,000		2,000,000	5,000,000	10,500,000
Total			2,000,000	1,500,000		2,000,000	5,000,000	10,500,000

Budget Impact/Other

Average annual debt service for \$3,500,000 = \$237,000

Capital Improvement Plan

Town of Newtown, Connecticut

'21/'22 thru '25/'26

Project # Fire - 1
Project Name Replacement of Fire Apparatus

Type Equipment Purchases
Useful Life 20
Category Vehicles
Department Fire
Contact Pat Reilly, Chairman, Board of Fi

Description

Scheduled replacement:

2022-23: Replacement (used) of Sandy Hook ladder truck which is 33 years old.
 2023-24: Replacement of Sandy Hook tanker which will be 25 years old (\$585,000) & refurbishment of Newtown Hook & Ladder ladder truck which will be 26 years old (\$450,000).
 2025-26: Replace Hawleyville engine truck which will be 25 years old (\$750,000).
 2026-27: Replace Sandy Hook engine truck which will be 24 years old (\$770,000).
 2027-28; Replace Botsford engine truck which will be 25 years old (\$790,000).

Justification

Scheduled replacement of existing fire apparatus due to their age. They will have reached their useful life and have become too costly to repair.

Expenditures	Prior	'21/'22	'22/'23	'23/'24	'24/'25	'25/'26	Future	Total
Equip/Vehicles/Furnishings			450,000	1,035,000		750,000	1,560,000	3,795,000
Total			450,000	1,035,000		750,000	1,560,000	3,795,000

Funding Sources	Prior	'21/'22	'22/'23	'23/'24	'24/'25	'25/'26	Future	Total
Bonding			450,000	800,000		750,000	1,560,000	3,560,000
Other				235,000				235,000
Total			450,000	1,035,000		750,000	1,560,000	3,795,000

Budget Impact/Other

There is no measurable operating budget impact relating to this project. Equipment maintenance expenditures will decrease for the Fire Commission. This will help keep down the annual budget requests of the Fire Commission.
 Average annual debt service for \$1,335,000 = \$90,000.

Capital Improvement Plan

Town of Newtown, Connecticut

'21/'22 *thru* '25/'26

Project # **LIB-1**
 Project Name **Library Building & Grounds Upgrades/Reno/Expansion**

Type Building construction/renovation Department Library
 Useful Life Contact Amy Dent, President, Board of Tr
 Category Buildings

Description

PLEASE SEE ATTACHED DESCRIPTION

Justification

SEE ATTACHED

Expenditures	Prior	'21/'22	'22/'23	'23/'24	'24/'25	'25/'26	Future	Total
Construction/Maintenance		200,000	550,000	1,046,000		1,000,000	450,000	3,246,000
Total		200,000	550,000	1,046,000		1,000,000	450,000	3,246,000

Funding Sources	Prior	'21/'22	'22/'23	'23/'24	'24/'25	'25/'26	Future	Total
Bonding		200,000	550,000	1,046,000		1,000,000	450,000	3,246,000
Total		200,000	550,000	1,046,000		1,000,000	450,000	3,246,000

Budget Impact/Other

- (1) Reduce maintenance and operating costs; ensure reliable HVAC performance.
 (2) Organize space to provide improved community access.

LIBRARY 2020-21 CIP REQUEST DETAIL:

2021-22

LIBRARY IMPROVEMENTS PROJECT - \$200,000

- Space Planning & Development Phase 3 - \$200,000

Description:

Long Range Space Planning and Development Phase 3: Reconstruct, realign and retrofit the Library's respective departments and study areas according to plan established by long-range planning.

Justification:

Long Range Space Planning & Development Phase 3 concludes building security, on ground floor, improves entry to upper floors, improves building rear entrance and improves ADA access to facility. These improvements are the result of extensive studies done in the long-term planning done by the Board of Trustees to keep the library an essential part of the community's range of services. Signage to direct patrons inside the library is rudimentary; signage outside the library is practically nonexistent.

2022-23

LIBRARY IMPROVEMENTS PROJECT - \$550,000

- Comprehensive HVAC upgrades - \$430,000

Description:

Replace the existing heating & cooling perimeter fan coil units throughout the rear building (date from 1997); existing cooling plant chambers and heat exchanger, (entire assembly). Reuse the existing chiller pumps and previously replaced through an earlier CIP project; Replace the existing gas fired steam boiler and heat that serves the entire facility.

Justification:

The library's existing fan coil units are beginning to fail due to internal clogging of the operating valves and up in the control valves and heating / cooling coils. Replacing these perimeter units will increase the efficiency of system and lower utility cost substantially. While the replacement of the chiller pumps & controls were addressed, Chilled water tower (plant) is original to the building (1997). The cooling coils, piping and mechanical valves have maintained regularly but preventive maintenance on this equipment has increased with valves and controls failing more frequently. The increased efficiency will lower electrical power consumption and operating costs. HVAC system was refurbished in 1997 when the rear building was erected. Without having a chemically treated water the heating & cooling system piping and heating / cooling equipment have become clogged, causing valves and to fail. With the efficiency and upgrades done to the heating system will lower utility costs by 15-20% during the season. Chiller plant, fan coil units, and HVAC boiler / heat exchanger are estimated to be at the end of their useful life and replacement is urgent.

- Slate Roof, Gutters & Downspout Replacement - \$120,000

Description:

Replacement of the existing slate shingled roof of the Original building located on Main Street. A new slate or approved composite roof shingle on the original building on Main Street. The project includes replacement of the gutters, down spouts & flashing as needed.

Justification:

The existing slate roof, flashing, integral gutters and down spouts are original to the 1932 structure.

LIBRARY IMPROVEMENTS PROJECT - \$650,000

- Repave parking lot; replace sidewalks - \$135,000

Description:

Completely repave parking lot with new asphalt down to substrate.

Justification:

Existing parking lot paving and patches date from all eras of library and show signs of end of-life. Significant safety hazards exist in parking lot and the seasonal wear and tear of plowing has destroyed curbing. Rainfall erodes aspects of parking lot each year. Sidewalks are significantly worn, spalled, uneven, and increasingly unsafe. Sidewalks present safety hazards, show significant spalling and other age-related damage, including frost heaves. The sidewalks are at 30+ years of age at this time.

- Meeting Space Re-envisioning - \$15,000

Description:

Refurbish and upgrade meeting rooms to accommodate needs of patrons and small businesses to provide timely, helpful, modern facilities.

Justification:

The library is in a unique position to leverage relatively low cost facilities for the purpose of supporting local small businesses which need meeting space, infrastructure, programming and responsive professionals. This project provides space for small businesses to thrive and grow the local economy.

- LED lighting, Exterior storage - \$100,000

Description:

Upgrades including but not limited to construction of additional exterior storage facility and internal LED lighting.

Justification:

Switching internal library lighting to LED will provide a significant amount of energy savings and cost reductions for many years to come. Exterior storage is needed to house equipment and property that is currently poorly cared for. The library's sole storage space is a partially climate-controlled attic; much material and equipment can be relocated for significant time savings in retrieval and also enable preservation for important stored material that includes much culturally significant objects and artifacts a longer life.

- Building upgrades incl. restrooms, flooring - \$200,000

Description:

Building upgrades, including but not limited to flooring as needed (e.g., carpeting, tile), bathroom upgrades, and signage specific to the interior and exterior of the facility.

Justification:

Six public restrooms including the Children's Department and main floor and upper level of facility date from the 1998 addition; ADA compliance and universal design elements are important components of attracting patrons of all ages and abilities to the library and keeping the facility safe, welcoming and comfortable. Carpeting and flooring in public areas is significantly degraded and shows signs of end-of-life. This upgrade also implements self-service options on ground floor, enhancing the facility's usefulness outside normal operating hours.

2022-23

LIBRARY IMPROVEMENTS PROJECT - \$650,000 – **CONTINUED**

- Study rooms / Flexible space / Office incubator - \$100,000

Description:

Reconstruct, realign and retrofit the Library's respective departments and study areas, established through long term planning. Includes flexible office space on upper floor, office incubator space(s) on upper floors, study rooms to be considered for all public areas of the library.

Justification:

The library continues to position itself as the primary source for partnerships with community groups of all kinds and seeks to emphasize and cement its role as one that fosters and supports successful local enterprises in terms of economic development of small businesses and firms.

- Window replacements - \$100,000

Description:

Windows in both eras of construction are original (1932 and 1998) and many are at the end of their lifespan. This phase completes urgent/critical repair projects begun in 2017-18.

Justification:

Repairs and upgrades to cracked and worn windows and components to include repainting and /or repointing and complete structural repairs. Both the Borough and the Historical Society will be consulted for Main Street aspects.

Capital Improvement Plan

Town of Newtown, Connecticut

'21/'22 thru '25/'26

Project # **P & R - 1**
 Project Name **Treadwell Artificial Turf & Lighting Replacement**

Type Park Improvements Department Parks & Recreation
 Useful Life 10 Contact AMY MANGOLD, DIRECTOR
 Category Land Improvements

Description

Replace artificial turf, regrade subsurface as needed. Artificial fields require replacement every 10-12 years.
 Replace 30 plus year old lamps with LED technology replace antiquated controllers, current lights and controllers are at the end of their service life.

Justification

At the end of assets useful life.

Expenditures	Prior	'21/'22	'22/'23	'23/'24	'24/'25	'25/'26	Future	Total
Other						800,000		800,000
Total						800,000		800,000

Funding Sources	Prior	'21/'22	'22/'23	'23/'24	'24/'25	'25/'26	Future	Total
Bonding						250,000		250,000
Other						550,000		550,000
Total						800,000		800,000

Budget Impact/Other

Capital Improvement Plan

Town of Newtown, Connecticut

'21/'22 thru '25/'26

Project # **P & R - 2**
Project Name **Rail Trail - Batchelder Park**

Type Land Improvements
Useful Life 35
Category Land Improvements

Department Parks & Recreation
Contact AMY MANGOLD, DIRECTOR

Description

Remove and clear old rail bed and convert to urban trail.

Justification

This project has been examined, requested and desired for over a decade. The brownfield contaminated area of Batchelder has not allowed any movement into Newtown from the Trumbull/Monroe rail area. A trail committee and the new initiatives in town, AARP, Healthy and Sustainable initiatives all identify this project as a large benefit to their initiatives in the Newtown community and surrounding communities.

Expenditures	Prior	'21/'22	'22/'23	'23/'24	'24/'25	'25/'26	Future	Total
Other						1,400,000		1,400,000
Total						1,400,000		1,400,000

Funding Sources	Prior	'21/'22	'22/'23	'23/'24	'24/'25	'25/'26	Future	Total
Grants						1,400,000		1,400,000
Total						1,400,000		1,400,000

Budget Impact/Other

Capital Improvement Plan

Town of Newtown, Connecticut

'21/'22 thru '25/'26

Project # **P & R - 3**
 Project Name **Lake Lillinonah Park Improvements**

Type Land Improvements Department Parks & Recreation
 Useful Life 25 Contact AMY MANGOLD, DIRECTOR
 Category Land Improvements

Description

Resurface parking lot, repair failing boat ramp, provide boat dockage and enlarged picnic area with pavilion.

Justification

Provide enhanced waterfront experience for those wishing to use lake Lillinonah and to offer slips to those waiting for slips at Eichler's Cove due to capacity. Revenue potential with pavilion, boat slips and potential gas dock.

Expenditures	Prior	'21/'22	'22/'23	'23/'24	'24/'25	'25/'26	Future	Total
Construction/Maintenance				500,000				500,000
Total				500,000				500,000

Funding Sources	Prior	'21/'22	'22/'23	'23/'24	'24/'25	'25/'26	Future	Total
Other				500,000				500,000
Total				500,000				500,000

Budget Impact/Other

Capital Improvement Plan

Town of Newtown, Connecticut

'21/'22 thru '25/'26

Project # **PW - 1**
Project Name **Capital Road Program**

Type Road Improvements
Useful Life 20
Category Infrastructure

Department Public Works
Contact FRED HURLEY, DIRECTOR O

Description

Complete reconstruction of aging roads.

The list of roads for each fiscal year is developed in May/June prior to the new fiscal year.

Justification

Maintain road system for safe passage of the public.

Expenditures	Prior	'21/'22	'22/'23	'23/'24	'24/'25	'25/'26	Future	Total
Construction/Maintenance		3,000,000	3,000,000	3,050,000	3,100,000	3,150,000	16,500,000	31,800,000
Total		3,000,000	3,000,000	3,050,000	3,100,000	3,150,000	16,500,000	31,800,000

Funding Sources	Prior	'21/'22	'22/'23	'23/'24	'24/'25	'25/'26	Future	Total
Bonding		500,000	250,000					750,000
General Fund		2,500,000	2,750,000	3,050,000	3,100,000	3,150,000	16,500,000	31,050,000
Total		3,000,000	3,000,000	3,050,000	3,100,000	3,150,000	16,500,000	31,800,000

Budget Impact/Other

The budget impact is that the road maintenance costs will be stable. The roads that are improved or replaced cost less to maintain, the roads we don't improve or replace cost more to maintain. So the recommended amounts we invest into roads enable us to have stable maintenance costs.

Average annual debt service cost on \$1,500,000 = \$101,000.

Capital Improvement Plan

Town of Newtown, Connecticut

'21/'22 thru '25/'26

Project # **PW - 2**
Project Name **Bridge Replacement Program**

Type Road Improvements
Useful Life 50
Category Infrastructure

Department Public Works
Contact FRED HURLEY, DIRECTOR O

Description

Bridge replacement program.

Planned annual amounts, once approved, will be placed in the capital projects fund in the bridge replacement line item. Bridges will be replaced one by one.

Justification

Public safety

Expenditures	Prior	'21/'22	'22/'23	'23/'24	'24/'25	'25/'26	Future	Total
Construction/Maintenance			400,000	400,000		400,000	1,600,000	2,800,000
Total			400,000	400,000		400,000	1,600,000	2,800,000

Funding Sources	Prior	'21/'22	'22/'23	'23/'24	'24/'25	'25/'26	Future	Total
Bonding			400,000	400,000		400,000	1,600,000	2,800,000
Total			400,000	400,000		400,000	1,600,000	2,800,000

Budget Impact/Other

The budget impact of replacing a bridge (at the right time) is that we avoid large maintenance costs.
Average annual debt service cost on \$400,000 = \$27,000.

Capital Improvement Plan

Town of Newtown, Connecticut

'21/'22 thru '25/'26

Project # **PW - 3**
 Project Name **Multi-Purpose Building Electrical/Mechanical/HVAC**

Type Building construction/renovation Department Public Works
 Useful Life 25 Contact FRED HURLEY, DIRECTOR O
 Category Buildings

Description

This facility was constructed in 1978, with several additions but no general overhaul and updating of the entire heating, ventilating and air conditioning systems (HVAC), electrical and other mechanical systems since then.

Justification

Improvements need to be made due to the age of the building

Expenditures	Prior	'21/'22	'22/'23	'23/'24	'24/'25	'25/'26	Future	Total
Construction/Maintenance				413,000				413,000
Total				413,000				413,000

Funding Sources	Prior	'21/'22	'22/'23	'23/'24	'24/'25	'25/'26	Future	Total
Bonding				413,000				413,000
Total				413,000				413,000

Budget Impact/Other

Less maintenance costs
 Average annual debt service cost = \$28,000.

Capital Improvement Plan

Town of Newtown, Connecticut

'21/'22 thru '25/'26

Project # **PW - 4**
 Project Name **Municipal Center - Roof Remediation & Replacement**

Type Building construction/renovation Department Public Works
 Useful Life 35 Contact FRED HURLEY, DIRECTOR O
 Category Buildings

Description

Roof remediation and replacement at the Municipal Center. Includes cupola repair & remediation of transite tiles.

Justification

Roof is reaching its useful life

Expenditures	Prior	'21/'22	'22/'23	'23/'24	'24/'25	'25/'26	Future	Total
Construction/Maintenance				1,000,000				1,000,000
Total				1,000,000				1,000,000

Funding Sources	Prior	'21/'22	'22/'23	'23/'24	'24/'25	'25/'26	Future	Total
Bonding				1,000,000				1,000,000
Total				1,000,000				1,000,000

Budget Impact/Other

Average annual debt service cost = \$67,000.

Capital Improvement Plan
Town of Newtown, Connecticut

'21/'22 thru '25/'26

Project #FS - 1

Project NameSandy Hook Permanent Memorial

TypeUnassigned

Useful Life25

CategoryUnassigned

DepartmentS.H. Permanent Memorial Comm

Contact

Description

A place holder for the Sandy Hook Permanent Memorial

Justification

Expenditures	Prior	'21/'22	'22/'23	'23/'24	'24/'25	'25/'26	Future	Total
Other		2,000,000	2,000,000					4,000,000
Total		2,000,000	2,000,000					4,000,000

Funding Sources	Prior	'21/'22	'22/'23	'23/'24	'24/'25	'25/'26	Future	Total
Bonding		2,000,000	2,000,000					4,000,000
Total		2,000,000	2,000,000					4,000,000

Budget Impact/Other

Average annual debt service on \$4,000,000 = \$270,000.

TOWN OF NEWTOWN 2021-2022 CIP FIVE YEAR FORECAST


		current yr	2021-22 TO 2025-26 CIP								
		2020-2021	2021 - 2022	2022- 2023	2023 - 2024	2024 - 2025	2025 - 2026	Total Est.			
		<u>Planned</u>	<u>Forecasted</u>	<u>Forecasted</u>	<u>Forecasted</u>	<u>Forecasted</u>	<u>Forecasted</u>	<u>Debt Service</u>			
<u>Fiscal</u>	<u>Current</u>	<u>2020 Bond</u>	<u>2021 Bond</u>	<u>2022 Bond</u>	<u>2023 Bond</u>	<u>2024 Bond</u>	<u>2025 Bond</u>	<u>Fiscal Year</u>	Forcasted	<u>General Fund</u>	<u>Debt</u>
<u>Years</u>	<u>Service</u>	<u>Issue</u>	<u>Issue</u>	<u>Issue</u>	<u>Issue</u>	<u>Issue</u>	<u>Issue</u>	<u>Service</u>			
<u>Ending</u>	<u>Schedule</u>	<u>(03/15/2021)</u>	<u>(03/15/2022)</u>	<u>(03/15/2023)</u>	<u>(03/15/2024)</u>	<u>(03/15/2025)</u>	<u>(03/15/2026)</u>	<u>Total</u>	Debt	<u>Budget</u>	<u>as a % of</u>
									Total	<u>Budget</u>	<u>Budget</u>
PRINCIPAL AMOUNT>>>		8,000,000	12,450,000	9,250,000	9,885,000	-	8,730,000	40,315,000	←	FIVE YEAR BORROWING AMOUNT	
06/30/2021	9,555,465							9,555,465	-	121,626,535	7.86%
06/30/2022	9,670,107	200,000						9,770,107	200,000	124,059,066	7.88%
06/30/2023	8,656,134	620,000	954,925					10,031,059	1,574,925	126,540,247	7.93%
06/30/2024	8,816,039	609,500	938,363	719,000				10,382,902	2,266,863	129,071,052	8.04%
06/30/2025	8,006,604	599,000	921,800	706,120	786,608			10,720,132	3,013,528	131,652,473	8.14%
06/30/2026	7,389,504	588,500	905,238	693,240	772,005	-		10,348,487	2,958,983	134,285,522	7.71%
06/30/2027	6,715,931	578,000	888,675	680,360	757,403	-	718,725	10,339,094	3,623,163	136,971,233	7.55%
06/30/2028	5,786,003	572,500	872,113	667,480	742,800	-	704,588	9,345,483	3,559,480	139,710,658	6.69%
06/30/2029	4,963,870	561,875	855,550	664,600	728,198	-	690,450	8,464,543	3,500,673	142,504,871	5.94%
06/30/2030	4,759,995	551,250	838,988	651,440	713,595	-	676,313	8,191,580	3,431,585	145,354,968	5.64%
06/30/2031	4,632,337	540,625	822,425	638,280	698,993	-	662,175	7,994,835	3,362,498	148,262,067	5.39%

premium applied from debt service fund.

Increase in Annual Debt Service:

Current Year Planned Bond Issue:			214,642	2.2%
			260,952	2.7%
<u>CIP Yr</u>	<u>Project</u>	<u>Amount</u>	351,843	3.5%
2020-21	capital road program	750,000	337,230	3.2%
	bridge replacement program	200,000	(371,645)	-3.5%
	new police facility	3,800,000	(9,393)	-0.1%
	emergency radio system upgrades	2,200,000		
	edmond town hall renovations	268,000		
2019-20	fire apparatus	550,000		
prior	high school addition	232,000		
		8,000,000		
2020-21	fairfield hills sewer - sewer fund	915,000		


**TOWN OF NEWTOWN
2021- 22 TO 2025-26 CIP EFFECT ON FUTURE DEBT SERVICE**

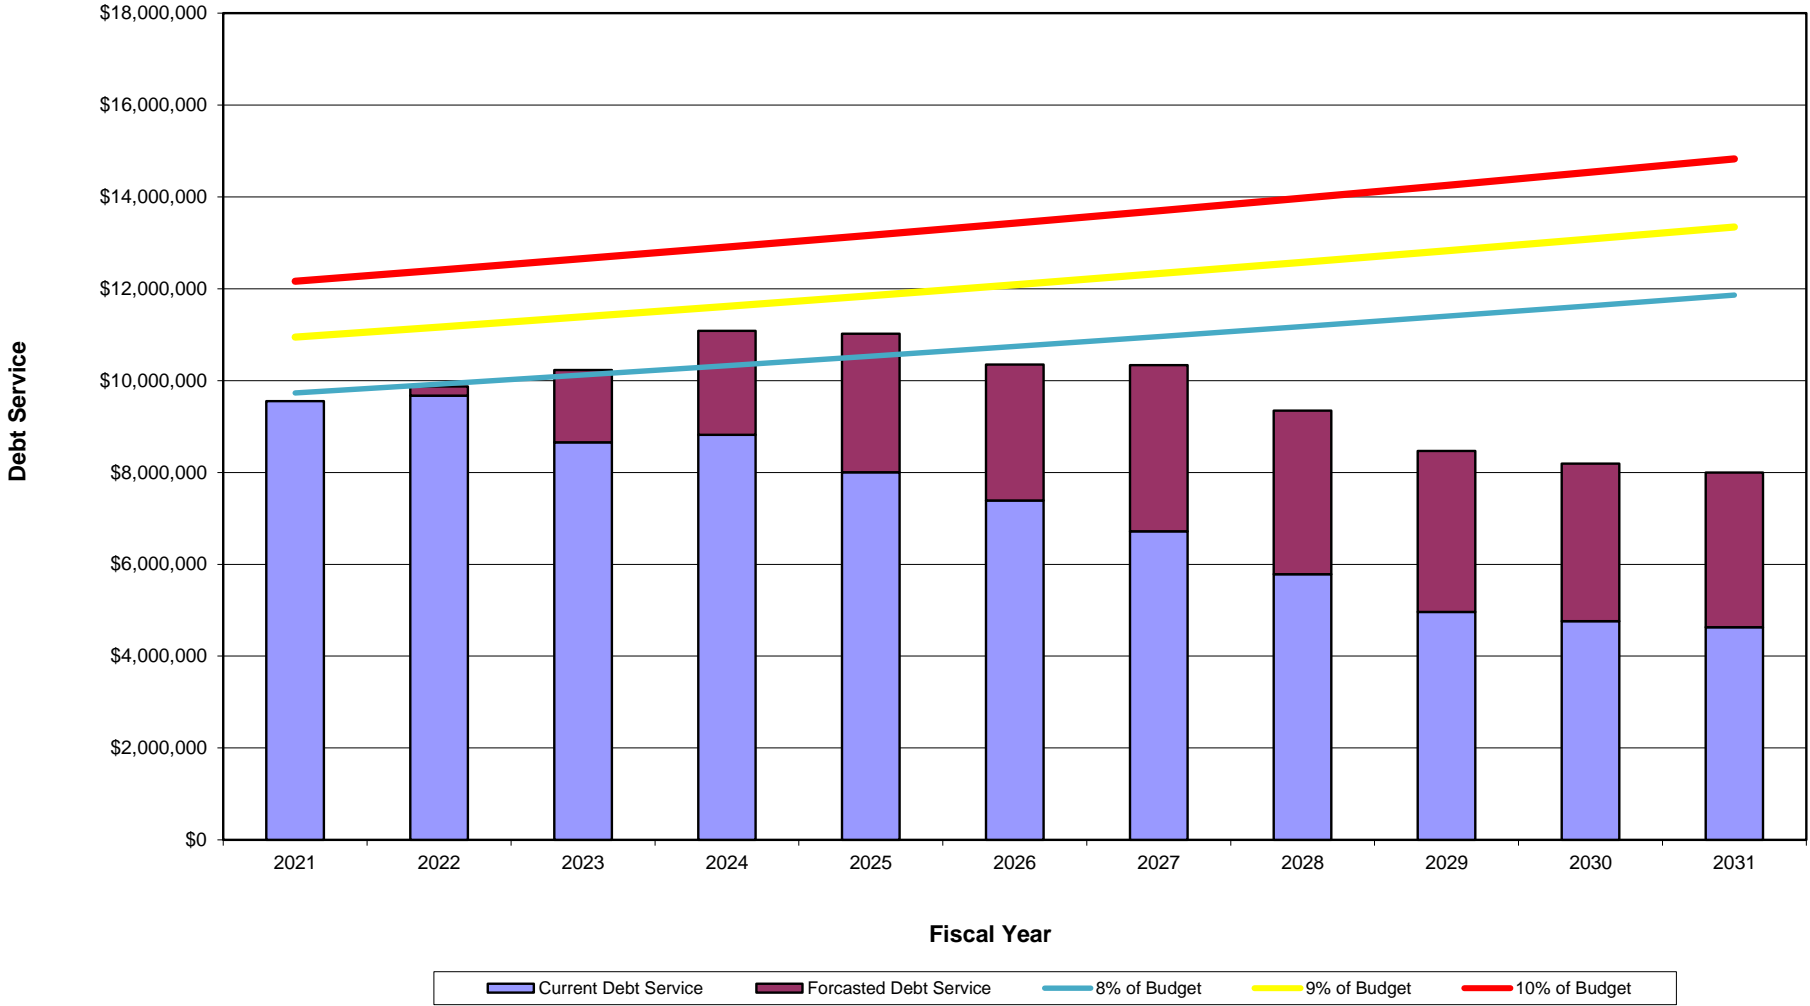

[illegible]

BOARD OF FINANCE CHANGES TO BOARD OF SELECTMEN/BOARD OF EDUCATION 2021-22 CIP:

- Year 1 – Hawley School Ventilation & HVAC for \$4,199,720 was spread over three years (with a total of \$8,000,000) which was based on Christopher Williams Architects Conceptual Estimate report.
 - **Year 1 - \$1,500,000; year 2 - \$2,500,000; year 3 - \$4,000,000.**
- Year 2 – Reed School – Install Gas Boiler/LED Lighting was **moved to year 1** (\$1,539,894).
- Year 3 – Middle School Improvements was **moved to year 5** (\$3,782,228). Year 2 – Middle School Improvements Design was **moved to year 3** (\$300,000).
- Year 5 – Middle Gate School Window Modifications (\$1,000,000) & High School Turf Practice Field (\$1,100,000) were **moved to year 6** (due to the shift of the Middle School Improvements project)
- Year 3 – Head O’Meadow School Boiler Plant & Lighting was **split into two projects** (\$850,000).
 - Year 3 – Head O’Meadow Boiler Plant for \$425,000
 - Year 1 – Head O’Meadow Lighting for \$425,000
- Year 5 – Hawley School New Generator was **moved to year 1** so that it could be planned with the Hawley School Ventilation & HVAC project.
- Year 3 – Library Renovations/Replacements/Upgrades **amount changed** from \$650,000 to \$1,046,000 (an additional \$396,000 to properly account for paving).
- Project name changes:
 - Middle School Improvements **changed** to Middle School HVAC
 - Middle School Improvements Design **changed** to Middle School HVAC Design
 - Multi-Purpose Building Improvements **changed** to Multi-Purpose Building Electrical/Mechanical/HVAC
- Year 6 – a **project was added to year 6**: Fairfield Hills Water Infrastructure for \$750,000 (under the “other” proposed funding category).

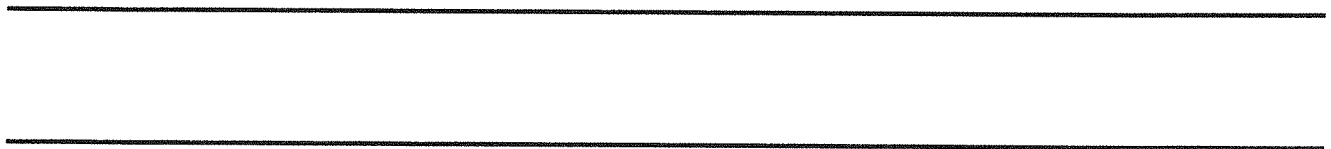

Hawley Elementary School
Newtown, CT
HVAC Upgrade

Conceptual Estimate

20-Nov-20

Prepared by:
MEP Cost LLC

For:
Christopher Williams Architects, LLC



Hawley Elementary School
Newtown, CT
HVAC Upgrade

Conceptual Estimate
Gross Floor Area (sf): 54,193
Date: 20-Nov-20

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Hawley Elementary School
Newtown, CT
HVAC Upgrade

Conceptual Estimate

Gross Floor Area (sf): 54,193
Date: 20-Nov-20

Basis of Estimate

Net Floor Area:

Phase 1 - Area C - 1921 Building	16,298	sf
Phase 2 - Area B (& 1997 classrooms) - 1948 Addition	25,710	sf
Phase 3 - Area A - 1997 Addition	12,185	sf
TOTAL	54,193	sf
 1921 Building Attic	 4,773	 sf

Information used in preparation of estimate:

Basis of Design Narrative Draft Report dated Oct. 24, 2020 by BVH Integrated Services
Photos of existing conditions provided by Christopher Williams Architects LLC
2012 Boiler Replacement project drawings
2005 HVAC Repairs drawings
Information received through emails, and in telephone discussions with BVH and CWA



Hawley Elementary School
Newtown, CT
HVAC Upgrade

Conceptual Estimate

Gross Floor Area (sf): 54,193
Date: 20-Nov-20

Clarifications & Exclusions

Clarifications:

The estimated construction durations are:

- Phase 1: 5 months for work in the 1921 building/Area C.
- Phase 2: 5 months for work in the 1948 addition/Area B.
- Phase 3: 2 months for work in the 1997 addition/Area A.

The estimated construction start dates are:

- June, 2021 for the 1921 building/Area C.
- June, 2022 for the 1948 addition/Area B.
- As desired for the 1997 addition/Area A.

As construction is desired to be phased and possibly performed during summer and other breaks, the estimate includes a 10% phasing premium, to account for multiple mobilizations/demobilizations, possible double shift premiums, possible night and weekend work premiums, temporary services/connections/reconnections, premiums for smaller work packages, etc.

This estimate is based on the use of a VAV reheat (variable air volume) HVAC system.

The estimate is based on prevailing wage rates for construction in this market, and represents a reasonable opinion of cost. It is not a prediction of the successful low bid from a contractor as bids will vary due to fluctuating market conditions, errors and omissions, proprietary specifications, a lack of or surplus of bidders, perception of risk, etc. Consequently the estimate is expected to fall within the range of bids from a number of competitive contractors or subcontractors.

Exclusions:

Costs associated with the following items are **NOT** included in the estimate:

- code upgrades (eg: building, seismic, fire alarm, fire protection, life safety, etc).
- firesafing of any existing penetrations.
- roof warranty extension (after repairs/patching for HVAC upgrade work).
- state sales tax.
- soft costs (design fees, bldg permits, etc).



Hawley Elementary School
Newtown, CT
HVAC Upgrade

Conceptual Estimate

Gross Floor Area (sf): 54,193
Date: 20-Nov-20

EXECUTIVE SUMMARY

Total

Phase 1 (Area C) - 1921 Building \$ 3,435,245

Phase 2 (Area B) - 1948 Addition (+ 1997 Classrooms) \$ 3,001,220

Phase 3 (Area A) - 1997 Addition \$ 832,072

TOTAL - All Phases \$ 7,268,537



Hawley Elementary School
Newtown, CT
HVAC Upgrade - Phase 1 - 1921

Conceptual Estimate

Net Floor Area (sf): 16,298
Date: 20-Nov-20

PHASE 1 - ESTIMATE SUMMARY

Description		\$/sf	Total
General Requirements			
01	General Requirements	5.95	97,000
Facility Construction			
02	Existing Conditions	10.26	167,208
04	Masonry	0.06	900
05	Metals	10.59	172,670
06	Wood & Plastics	1.84	29,950
07	Thermal and Moisture Protection	7.43	121,022
08	Openings	2.33	38,025
09	Finishes	6.87	111,921
10	Specialties		
Facility Services			
22	Plumbing	0.64	10,500
23	Heating Ventilating and Air Conditioning	80.33	1,309,273
26	Electrical	15.83	258,027
Site and Infrastructure			
32	Exterior Improvements		
33	Utilities		
Sub-Total:		142.13	\$ 2,316,496
	Design & Pricing Contingency	10.00%	231,650
	Construction Contingency	3.00%	76,444
	Insurance (General Liability & Workers Compensation)	2.00%	52,492
	Performance and Payment Bond	1.00%	26,771
	General Conditions/Overhead/Profit	12.50%	337,982
	Escalation - to June 2021 @ 6% per annum	3.00%	81,116
	Phasing premium	10.00%	312,295
Total Construction Cost:		210.78	\$ 3,435,245

**Hawley Elementary School
Newtown, CT
HVAC Upgrade - Phase 1 - 1921**

Conceptual Estimate

Net Floor Area (sf): 16,298
Date: 20-Nov-20

Description		Quantity	Unit	Unit Cost	Total
GENERAL REQUIREMENTS					
01 GENERAL REQUIREMENTS					
Temporary Facilities & Controls					
Dust control (place & remove, cleanup, removal of demo'd materials), moving desks & chairs / floor protection	5	mos	10,000.00		50,000
Dumpster, 4 pulls per month	5	mos	6,400.00		32,000
Cut & patch site surfaces for new incoming electrical service	1	alw	15,000.00		15,000
Temporary protection at new dormer opening	300	sf	10.00		3,000
Temporary Facilities & Controls					97,000
TOTAL GENERAL REQUIREMENTS				\$	97,000
FACILITY CONSTRUCTION					
02 EXISTING CONDITIONS					
Removal and Salvage of Construction Materials					
Demo ceilings for installation of electrical wiring, duct, etc	5,984	sf	2.00		11,968
Cutting masonry walls for new ductwork distribution across corridor	10	ea	300.00		3,000
Core drilling of masonry walls for new piping/conduit distribution across corridor	50	ea	130.00		6,500
Cut hole through slabs for new ductwork and piping	15	ea	1,000.00		15,000
Cut openings in roof for new steel column extensions (or ties to beams) for support of new AHUs, low roof of 1921 building	8	ea	500.00		4,000
Cut holes in roof/structure for elec feeders to mech equip, & heating piping for AHUs	2	locns	1,000.00		2,000
Remove existing boxed out skylights at low 1921 roof	2	ea	2,500.00		5,000
Remove existing attic dormers and windows for new shed dormer	3	locns	1,500.00		4,500
Remove existing attic dormers and windows for new shed dormer	3	locns	1,500.00		4,500
Sawcut and remove top of masonry exterior wall to facilitate new dormer transition	31	lf	40.00		1,240
Brace opening at new dormer location during and after demo	350	sf	10.00		3,500
X-ray of floor/roof slabs in 1921 areas before coring/cutting holes	1	alw	4,500.00		4,500
Removal and Salvage of Construction Materials					65,708
Facility Remediation					
Spot Lead Abatement for cutting masonry walls x corridor	56	ea	250.00		14,000
Spot Lead Abatement for core drilling x corridor	140	ea	100.00		14,000
Spot Lead Abatement for piping/conduits	400	ea	50.00		20,000
Spot Asbestos Abatement for piping/conduits	25	ea	50.00		1,250
Cleaning of Attic & sealing	1	alw	10,000.00		10,000
Abatement of hidden asbestos pipe insulation in way	2	ea	2,500.00		5,000
Abatement of asbestos caulk at 1921 doors	50	lf	20.00		1,000
Asbestos transport & disposal	1	alw	1,250.00		1,250
Lead paint transport & disposal	1	alw	5,000.00		5,000
PCB transport & disposal	1	alw	5,000.00		5,000
3rd party testing & monitoring	1	alw	25,000.00		25,000
Facility Remediation					101,500



Hawley Elementary School
Newtown, CT
HVAC Upgrade - Phase 1 - 1921

Conceptual Estimate
Net Floor Area (sf): 16,298
Date: 20-Nov-20

	Description	Quantity	Unit	Unit Cost	Total
	TOTAL EXISTING CONDITIONS				\$ 167,208
04	MASONRY				
	Brick Masonry				
	Modify top of existing masonry ext. wall at new dormer	30	lf	30.00	900
	Brick Masonry				900
	TOTAL MASONRY				\$ 900
05	METALS				
	Misc Metals				
	Misc metal angles at openings in floor & roof for new shafts	50	ea	750.00	37,500
	Misc metal angles at openings in walls for new shafts	10	ea	500.00	5,000
	Add galv steel dunnage to support of new units on multi-purpose room roof	2	ton	6,400.00	9,600
	Add ledger angles or other misc metals at top wall/bottom dormer	31	lf	35.00	1,085
	Cover openings left by demo'd skylights with metal roof deck - use hilti connectors to attach to existing concrete	256	sf	10.00	2,560
	Add angle supports at edge of skylight opening (incl repair perim)	93	lf	25.00	2,325
	Add steel supports in attic to distribute weight of new units	10	ton	8,000.00	80,000
	Screenwall, galvanized supports (20 lbs per sf of screenwall)	4	ton	6,400.00	25,600
	Screenwall 4'-0" high, edge of flat roof of 1921 building	360	sf	25.00	9,000
	Misc Metals				172,670
	TOTAL METALS				\$ 172,670
06	WOOD & PLASTICS				
	Rough Carpentry				
	Frame new shed dormer, including remove bracing left by demo sub	350	sf	40.00	14,000
	Sheathing and vapor barrier on dormer	600	sf	12.00	7,200
	Hardee plank siding at face with louvers; piece work	80	sf	20.00	1,600
	Trex trim at sides and edge of dormer; allow for trim at ex. Roofline	30	lf	25.00	750
	Rough Carpentry				23,550
	Finish Carpentry				
	Remove and replace classroom cabinetry to facilitate duct risers	8	locns	800.00	6,400
	Finish Carpentry				6,400
	TOTAL WOOD & PLASTICS				\$ 29,950
07	THERMAL and MOISTURE PROTECTION				
	Roofing				
	Provide new 2" thick conc pavers to/from cond units	100	sf	3.00	300
	New EPDM roof on dormer, including alum edging/trim	350	sf	28.00	9,800
	Copper flashing at valley and on sides of dormer	130	sf	35.00	4,550
	New roof at low 1921 roof, including sheathing, insulation, flashing for MEP piping & equipment curbs	1,924	sf	28.00	53,872

Hawley Elementary School
Newtown, CT
HVAC Upgrade - Phase 1 - 1921

Conceptual Estimate

Net Floor Area (sf): 16,298

Date: 20-Nov-20

	Description	Quantity	Unit	Unit Cost	Total
	Provide insulation at existing attic - closed cell spray polyurethane applied between rafters to underside of roof shathing -2" thick.	7,000	sf	6.00	42,000
	Hard coat ignition barrier over spray insul for fire rating	7,000	sf	1.50	10,500
	Roofing				121,022
	TOTAL THERMAL and MOISTURE PROTECTION				\$ 121,022
08	OPENINGS				
	Louvers				
	New louvers at attic dormer	169	sf	225.00	38,025
	Louvers				38,025
	TOTAL OPENINGS				\$ 38,025
09	FINISHES				
	Gypsum Board				
	Build new pipe/duct enclosure/shafts through 1st & 2nd floors, assume 2-2'x2' pipe shafts & 3-3'x4' duct shafts, including bulk heads. Includes bulkheads at new suspended ceilings	1,000	sf	25.00	25,000
	New soffits	1,100	sf	15.00	16,500
	Gypsum Board				41,500
	Ceilings				
	Add new drop ceiling to rooms with no existing drop ceiling	3,130	sf	6.50	20,345
	FULL - replace demo'd T-bar ceiling grid & tiles for installation of ductwork, control wiring, electrical wiring, etc	5,984	sf	6.50	38,896
	PARTIAL - Remove & replace T-bar ceiling tiles for installation of ductwork, control wiring, electrical wiring, etc	339	sf	3.50	1,187
	Replace 25% of removed ceiling tiles due to breakage after removal for HVAC upgrade	85	sf	3.50	297
	Replace 25% of T-bar ceiling grid damaged during HVAC upgrade and/or for installation of ductwork	85	sf	3.50	297
	Ceilings				61,021
	Painting and Coatings				
	Paint new gyp bd bulkheads, soffits & shafts	2,200	sf	2.00	4,400
	Allowance for touch up of wall/surface areas damaged during HVAC upgrade	1	alw	5,000.00	5,000
	Painting and Coatings				9,400
	TOTAL FINISHES				\$ 111,921
FACILITY SERVICES					
22	PLUMBING				
	Plumbing Fixtures & Related Services				
	Floor drain w/trap guard (in attic) incl sanitary drainage piping (for AHU cooling coil cond drain)	3	ea	3,500.00	10,500
	Plumbing Fixtures & Related Services				10,500



**Hawley Elementary School
Newtown, CT
HVAC Upgrade - Phase 1 - 1921**

Conceptual Estimate

Net Floor Area (sf): 16,298

Date: 20-Nov-20

	Description	Quantity	Unit	Unit Cost	Total
	TOTAL PLUMBING				\$ 10,500
23	HEATING VENTILATING and AIR CONDITIONING				
	Heating				
	Existing heating water plant, pumps, exp tanks, air separators, piping, perimeter finned tube radiation, etc				ETR
	Connect to exist heating water lines	2	ea	453.56	907
	Cabinet unit heater, hot water (for 1921 area C)	2	ea	2,210.00	4,420
	Heating water piping, 3" dia	227	lf	67.60	15,345
	Heating water piping, 2" dia	53	lf	59.31	3,143
	Heating water piping, 1 1/2" dia	257	lf	47.41	12,184
	Heating water piping, 1 1/4" dia	83	lf	42.30	3,511
	Heating water piping, 1" dia	185	lf	34.76	6,431
	Heating water piping, 3/4" dia	560	lf	28.10	15,736
	Local heating water piping rough-in & conn at AHU	4	ea	2,833.84	11,335
	Local heating water piping rough-in & conn at new CUH	2	ea	1,164.59	2,329
	Local heating water piping rough-in & conn at VAV box reheat coil	22	ea	1,407.84	30,972
	Valves & specialties (thermometers, pressure gauges, test fittings, air vents, flex pipe conns, access panels, drain pans, backflow preventors)	1	ls	8,500.00	8,500
	Pipe insulation, 1 1/2" thick, 3" dia	227	lf	13.29	3,017
	Pipe insulation, 1 1/2" thick, 2" dia	53	lf	12.69	673
	Pipe insulation, 1 1/2" thick, 1 1/2" dia	257	lf	11.88	3,053
	Pipe insulation, 1 1/2" thick, 1 1/4" dia	83	lf	11.69	970
	Pipe insulation, 1 1/2" thick, 1" dia	185	lf	11.32	2,094
	Pipe insulation, 1 1/2" thick, 3/4" dia	560	lf	11.06	6,194
	Heating				130,815
	Cooling				
	Refrigerant piping, insulated, between AHUs & condensing units	4	ea	3,500.00	14,000
	Cooling				14,000
	Air Distribution				
	AHU-C w/split cond unit, 8000 cfm (assembled on site)	2	ea	94,175.00	188,350
	AHU-C-Cafe w/split cond unit & heat recovery, 2500 cfm (assembled on site)	1	ea	33,075.00	33,075
	AHU-C-Multi-Purpose w/split cond unit & heat recovery, 2800 cfm (assembled on site)	1	ea	33,075.00	33,075
	Bi-polar ionization units				not included
	Sound attenuators for AHU supply & return ducts	42,600	cfm	0.50	21,300
	VAV box w/hot water reheat coil	22	ea	1,164.22	25,613
	Toilet rooms exhaust, janitor room exhaust, misc exh systems	1	alw	10,000.00	10,000
	Kitchen exhaust fan & ductwork	1	alw	15,000.00	15,000
	HVAC systems for boiler & elec rooms - to remain as is				ETR
	Galv steel duct, med press incl scrap, waste, hangers	5,987	lbs	13.82	82,740
	Galv steel duct, low press incl scrap, waste, hangers	20,080	lbs	12.33	247,586
	Relief & outside air plenums for louvers	540	sf	41.10	22,194
	Duct insulation, external, thermal, 3/4 # density, 1 1/2" thick	17,060	sf	3.35	57,151
	Air outlet, supply	73	ea	235.09	17,162



**Hawley Elementary School
Newtown, CT
HVAC Upgrade - Phase 1 - 1921**

Conceptual Estimate

Net Floor Area (sf): 16,298

Date: 20-Nov-20

Description	Quantity	Unit	Unit Cost	Total
Air outlet, return	37	ea	199.35	7,376
Manual balancing dampers	73	ea	136.31	9,951
Flexible duct	511	lf	25.93	13,250
Fire/smoke dampers, small (for 1921 area C)	8	alw	1,724.99	13,800
Air Distribution				797,623
Testing, Adjusting, and Balancing for HVAC				
Testing, adjusting & balancing air & (new) water systems	180	hrs	105.00	18,900
Testing, Adjusting, and Balancing for HVAC				18,900
Controls				
DDC BAS system budget provided by ABS-DDC (incl head end equip for all phases)	1	ls	194,000.00	194,000
Controls				194,000
HVAC Demolition				
Demo all exist HVAC systems in 1921 area C (except perim heat)	19,870	sf	0.50	9,935
Demo exist split system ACUs in 1921 area C multipurpose room	4	ea	1,000.00	4,000
HVAC Demolition				13,935
Miscellaneous HVAC				
Firesafing (at new penetrations only)	1	alw	5,000.00	5,000
Coord & As-Builts (3% labor)	1	ls	17,600.00	17,600
Daily cleanup (3% labor)	1	ls	17,600.00	17,600
Small tools & consum (4% labor)	1	ls	23,500.00	23,500
Equip Rental (2% labor)	1	ls	11,700.00	11,700
Startup (2% material)	1	ls	11,700.00	11,700
Warranty (0.5% material & labor)	1	ls	5,900.00	5,900
Supervision (8% labor)	1	ls	47,000.00	47,000
Miscellaneous HVAC				140,000

TOTAL HEATING VENTILATING and AIR CONDITIONING

\$ 1,309,273



**Hawley Elementary School
Newtown, CT
HVAC Upgrade - Phase 1 - 1921**

Conceptual Estimate

Net Floor Area (sf): 16,298
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		Description	Quantity	Unit	Unit Cost	Total
26	ELECTRICAL					
		Cabling, Conductors, Raceway				
		<u>New electrical equip & feeders for new mech motor/equip loads:</u>				
		New primary power service duct bank (2x5")	100	lf	30.00	3,000
		Excavation, backfill and concrete for primary duct bank	100	lf	20.00	2,000
		Grounding for transformer	1	ea	1,100.00	1,100
		New secondary power service duct bank (6x4")	50	lf	45.00	2,250
		Excavation, backfill and concrete for secondary duct bank	50	lf	40.00	2,000
		500 MCM XHHW str copper in duct bank	960	lf	15.00	14,400
		#1/0 AWG XHHW str copper in duct bank	240	lf	4.11	986
		New Main Switchboard 1600A 208V MCB w/1200A CB to backfeed existing Main Switchboard	1	ea	87,500.00	87,500
		1200A feeder to backfeed existing MSB	100	lf	300.00	30,000
		Splice 1200A feeder	1	ea	4,500.00	4,500
		<u>Building Electrical:</u>				
		Connect to Condensing Unit 30ton w/safety switch (wp)	2	ea	1,000.00	2,000
		Connect to Condensing Unit 12ton w/safety switch (wp)	2	ea	700.00	1,400
		Connect to AHU 8000CFM w/safety switch	2	ea	750.00	1,500
		Connect to AHU 2500CFM w/safety switch	2	ea	300.00	600
		Connect to VAV boxes	22	ea	263.00	5,786
		Connect to cabinet unit heater	2	ea	110.00	220
		200A motor feeder	200	lf	52.00	10,400
		175A motor feeder	200	lf	45.00	9,000
		70A motor feeder	200	lf	24.00	4,800
		60A motor feeder	200	lf	18.00	3,600
		20A motor feeder	1,000	lf	12.00	12,000
		Commissioning/Checkout/Test	1	ea	5,250.00	5,250
		Remove light fixts in demo'd ceilings & later reinstall in new ceilings	69	ea	415.00	28,635
		New light fixtures incl wiring	30	ea	500.00	15,000
		Remove, temporarily support & replace exist cameras, speakers, FA devices, WAPs, etc, mounted in ceiling, for removal & replacement of ceiling tiles/grid to allow installation of ductwork, electrical wiring	2	ea	50.00	100
		Duct smoke detectors (1 per unit) & conns to fire alarm system	1	alw	10,000.00	10,000
		Cabling, Conductors, Raceway				258,027
	TOTAL ELECTRICAL					\$ 258,027



Hawley Elementary School
Newtown, CT
HVAC Upgrade - Phase 2 - 1948 (+ 1997 Classrooms)

Conceptual Estimate

Net Floor Area (sf): 25,710
Date: 20-Nov-20

PHASE 2 - ESTIMATE SUMMARY

Description		\$/sf	Total
General Requirements			
01	General Requirements	3.19	82,000
Facility Construction			
02	Existing Conditions	8.57	220,250
03	Concrete	0.12	3,000
04	Masonry	1.57	40,400
05	Metals	2.94	75,658
06	Wood & Plastics	0.12	3,200
07	Thermal and Moisture Protection	0.93	24,000
08	Openings		
09	Finishes	4.95	127,371
10	Specialties		
Facility Services			
23	Heating Ventilating and Air Conditioning	46.93	1,206,506
26	Electrical	5.50	141,492
Site and Infrastructure			
32	Exterior Improvements		
33	Utilities		
Sub-Total:		74.83	\$ 1,923,877
	Design & Pricing Contingency	10.00%	192,388
	Construction Contingency	3.00%	63,488
	Insurance (General Liability & Workers Compensation)	2.00%	43,595
	Performance and Payment Bond	1.00%	22,233
	General Conditions/Overhead/Profit	12.50%	280,698
	Escalation - to June 2022 @ 6% per annum	9.00%	202,102
	Phasing premium	10.00%	272,838
Total Construction Cost:		116.73	\$ 3,001,220



Hawley Elementary School
Newtown, CT
HVAC Upgrade - Phase 2 - 1948 (+ 1997 Classrooms)

Conceptual Estimate

Net Floor Area (sf): 25,710
Date: 20-Nov-20

	Description	Quantity	Unit	Unit Cost	Total
GENERAL REQUIREMENTS					
01	GENERAL REQUIREMENTS				
	Temporary Facilities & Controls				
	Dust control (place & remove, cleanup, removal of demo'd materials), moving desks & chairs / floor protection	5	mos	10,000.00	50,000
	Dumpster, 4 pulls per month	5	mos	6,400.00	32,000
	Allow for carpenters, misc safety and temporary partitions	100	hr	60.00	6,000
	Temporary Facilities & Controls				82,000
	TOTAL GENERAL REQUIREMENTS			\$	82,000
FACILITY CONSTRUCTION					
02	EXISTING CONDITIONS				
	Removal and Salvage of Construction Materials				
	Demo ceilings for installation of electrical wiring, duct, etc	13,225	sf	2.00	26,450
	Cutting block walls for new ductwork distribution across corridor	74	ea	500.00	37,000
	Core drilling of block walls for new piping/conduit distribution across corridor	111	ea	300.00	33,300
	Cut hole through floors for new ductwork and piping	8	ea	1,000.00	8,000
	Cut holes in walls/floors for installation of new elec panelboards, conduits, ducts, etc (NOTE: lead based paint on walls in 1948 areas)	1	alw	5,000.00	5,000
	Cut holes in roof for ducts from new RTUs	8	ea	1,500.00	12,000
	Cut holes in roof/structure for elec feeders to mech equip & heating piping for RTUs	8	ea	1,000.00	8,000
	Removal and Salvage of Construction Materials				129,750
	Facility Remediation				
	Small Asbestos Abatement for 2x2 duct holes in floor	8	ea	2,000.00	16,000
	Spot Lead Abatement for piping/conduits	100	ea	50.00	5,000
	Spot Asbestos Abatement for piping/conduits	75	ea	50.00	3,750
	Vinyl Floor Tile abatement in 2 Electrical Rooms	2	ea	3,500.00	7,000
	Abatement of hidden asbestos pipe insulation in way	8	ea	2,500.00	20,000
	Trim trees that overhang roof	1	alw	10,000.00	10,000
	Asbestos transport & disposal	1	alw	3,750.00	3,750
	3rd party testing & monitoring	1	alw	25,000.00	25,000
	Facility Remediation				90,500
	TOTAL EXISTING CONDITIONS			\$	220,250
03	CONCRETE				
	Cast-in-Place Concrete				
	Patch/cover/seal openings in roof for demo'd exhaust fans	1	alw	3,000.00	3,000
	Cast-in-Place Concrete				3,000
	TOTAL CONCRETE			\$	3,000



Hawley Elementary School
Newtown, CT
HVAC Upgrade - Phase 2 - 1948 (+ 1997 Classrooms)

Conceptual Estimate

Net Floor Area (sf): 25,710

Date: 20-Nov-20

	Description	Quantity	Unit	Unit Cost	Total
04	MASONRY				
	Brick Masonry				
	<u>Modifications to exist block walls to support steel beams for RTUs:</u>				
	Cut beam pockets in block walls at locations to receive RTU support beams	32	locns	200.00	6,400
	Grout cells solid; add reinforcing steel at new beam locations	32	locns	800.00	25,600
	Set base plates provided by steel contractor	32	ea	75.00	2,400
	Drypack around steel beams after steel contractor sets beams	16	beams	250.00	4,000
	Repair damaged block in locations with new RTUs - assume 100 sf at each l	400	sf	5.00	2,000
	Brick Masonry				40,400
	TOTAL MASONRY			\$	40,400
05	METALS				
	Misc Metals				
	Misc metal angles at openings in floor & roof for new shafts	27	ea	750.00	20,250
	Misc metal angles at openings in walls for new ducts	74	ea	500.00	37,000
	Add steel beams to support of new rooftop units	2	ton	9,000.00	13,608
	Furnish base plates to masonry contractor to anchor in block pocket	32	ea	150.00	4,800
	Misc Metals				75,658
	TOTAL METALS			\$	75,658
06	WOOD & PLASTICS				
	Finish Carpentry				
	Remove and replace classroom cabinetry to facilitate duct risers	4	rms	800.00	3,200
	Finish Carpentry				3,200
	TOTAL WOOD & PLASTICS			\$	3,200
07	THERMAL and MOISTURE PROTECTION				
	Roofing				
	Re-roof/patch at new RTU curbs	6	ea	2,500.00	15,000
	Patch openings in roof for demo'd refrig piping	2	ea	500.00	1,000
	Provide new 2" thick conc pavers to/from RTUs	1,000	sf	3.00	3,000
	Flash & patch hole in roof for elec feeders to mech equip & heating piping for RTUs	100	sf	30.00	3,000
	Roof patching/flashings after new RTU curbs & duct penetrations installed	4	ea	500.00	2,000
	Roofing				24,000
	TOTAL THERMAL and MOISTURE PROTECTION			\$	24,000



**Hawley Elementary School
Newtown, CT
HVAC Upgrade - Phase 2 - 1948 (+ 1997 Classrooms)**

Conceptual Estimate

Net Floor Area (sf): 25,710
Date: 20-Nov-20

	Description	Quantity	Unit	Unit Cost	Total
09	FINISHES				
	Gypsum Board				
	Build new pipe/duct enclosure/shafts through 2nd floor, assume 2-2'x2' pipe shafts & 3-3'x4' duct shafts, including bulk heads. Includes bulkheads at new suspended ceilings	1,000	sf	25.00	25,000
	Gypsum Board				25,000
	Ceilings				
	FULL - replace demo'd T-bar ceiling grid & tiles for installation of ductwork, control wiring, electrical wiring, etc	13,225	sf	6.50	85,963
	PARTIAL - Remove & replace T-bar ceiling tiles for installation of ductwork, control wiring, electrical wiring, etc	2,173	sf	3.50	7,606
	Replace 25% of removed ceiling tiles due to breakage after removal for HVAC upgrade	543	sf	3.50	1,901
	Replace 25% of T-bar ceiling grid damaged during HVAC upgrade and/or for installation of ductwork	543	sf	3.50	1,901
	Ceilings				97,371
	Painting and Coatings				
	Allowance for touch up of wall/surface areas damaged during HVAC upgrade & after demo of split system AC units	1	alw	5,000.00	5,000
	Painting and Coatings				5,000
	TOTAL FINISHES				\$ 127,371

FACILITY SERVICES

23 HEATING VENTILATING and AIR CONDITIONING

	Heating				
	Existing heating water plant, pumps, exp tanks, air separators, piping, perimeter finned tube radiation, etc				ETR
	Connect to exist heating water lines	2	ea	453.56	907
	Heating water piping, avg 1 1/4" dia	1,500	lf	42.30	63,450
	Local heating water piping rough-in & conn at RTU	4	ea	2,833.84	11,335
	Local heating water piping rough-in & conn at VAV box reheat coil	24	ea	1,407.84	33,788
	Valves & specialties (thermometers, pressure gauges, test fittings, air vents, flex pipe conns, access panels, drain pans, backflow preventors)	1	ls	9,600.00	9,600
	Pipe insulation, 1 1/2" thick, avg 1 1/4" dia	1,500	lf	11.69	17,535
	Heating				136,616
	Cooling				
	Split system ACU incl indoor unit, outdoor condensing unit & insulated refig piping, for area requiring 24/7 cooling	1	alw	9,500.00	9,500
	Cooling				9,500



Hawley Elementary School
Newtown, CT
HVAC Upgrade - Phase 2 - 1948 (+ 1997 Classrooms)

Conceptual Estimate

Net Floor Area (sf): 25,710

Date: 20-Nov-20

Description	Quantity	Unit	Unit Cost	Total
Air Distribution				
RTU-B1-1, 5500 cfm	1	ea	34,192.00	34,192
RTU-B1-2, 5000 cfm	1	ea	34,192.00	34,192
RTU-B2-1 w/heat recovery, 6500 cfm	1	ea	88,242.00	88,242
RTU-B2-2, 5000 cfm	1	ea	34,192.00	34,192
Bi-polar ionization units				<i>not included</i>
Sound attenuators for RTU supply & return ducts	44,000	cfm	0.50	22,000
VAV box w/hot water reheat coil (1/900 cfm)	24	ea	1,164.22	27,941
Toilet rooms exhaust, janitor room exhaust, misc exh systems	1	alw	20,000.00	20,000
HVAC systems for boiler & elec rooms - to remain as is				<i>ETR</i>
Galv steel duct, med press incl scrap, waste, hangers	6,160	lbs	13.82	85,131
Galv steel duct, low press incl scrap, waste, hangers	20,680	lbs	12.33	254,984
Duct insulation, external, thermal, 3/4 # density, 1 1/2" thick	17,446	sf	3.35	58,444
Duct insulation, external, thermal w/alum jacket for ductwork exposed at roof	600	sf	17.75	10,650
Air outlet, supply (1/300 cfm)	73	ea	235.09	17,162
Air outlet, return (1/500 cfm)	44	ea	199.35	8,771
Manual balancing dampers	73	ea	136.31	9,951
Flexible duct	511	lf	25.93	13,250
Air Distribution				719,103
Testing, Adjusting, and Balancing for HVAC				
Testing, adjusting & balancing air & (new) water systems	190	hrs	105.00	19,950
Testing, Adjusting, and Balancing for HVAC				19,950
Controls				
DDC BAS system budget provided by ABS-DDC	1	ls	165,000.00	165,000
Controls				165,000
HVAC Demolition				
Demo exhaust ducts & fans in 1948 area B	21,876	sf	0.50	10,938
Demo exist split system ACUs in M206 & M207	2	ea	1,000.00	2,000
Demo misc items not identified above (allowance)	1	alw	10,000.00	10,000
HVAC Demolition				22,938
Miscellaneous HVAC				
Firesafing (at new penetrations only)	1	alw	5,000.00	5,000
Coord & As-Builts (3% labor)	1	ls	16,100.00	16,100
Daily cleanup (3% labor)	1	ls	16,100.00	16,100
Small tools & consum (4% labor)	1	ls	21,500.00	21,500
Equip Rental (2% labor)	1	ls	10,700.00	10,700
Rigging/Cranes	1	ls	5,000.00	5,000
Startup (2% material)	1	ls	10,700.00	10,700
Warranty (0.5% material & labor)	1	ls	5,400.00	5,400
Supervision (8% labor)	1	ls	42,900.00	42,900
Miscellaneous HVAC				133,400



**Hawley Elementary School
Newtown, CT
HVAC Upgrade - Phase 2 - 1948 (+ 1997 Classrooms)**

Conceptual Estimate

Net Floor Area (sf): 25,710

Date: 20-Nov-20

		Description	Quantity	Unit	Unit Cost	Total
TOTAL HEATING VENTILATING and AIR CONDITIONING						\$ 1,206,506
26	ELECTRICAL					
	Cabling, Conductors, Raceway					
		Connect and feed 15ton RTU with safety switch (wp)	4	ea	1,000.00	4,000
		Connect to VAV boxes w/manual starters	24	ea	263.00	6,312
		150A motor feeder	400	lf	42.00	16,800
		20A motor feeder	960	lf	12.00	11,520
		Remove light fixts in demo'd ceilings & later reinstall in new ceilings	214	ea	415.00	88,810
		Remove, temporarily support & replace exist cameras, speakers, FA devices, WAPs, etc, mounted in ceiling, for removal & replacement of ceiling tiles/grid to allow installation of ductwork, electrical wiring	81	ea	50.00	4,050
		Duct smoke detectors (1 per unit) & conns to fire alarm system	1	alw	10,000.00	10,000
		Cabling, Conductors, Raceway				141,492
TOTAL ELECTRICAL						\$ 141,492



Hawley Elementary School
Newtown, CT
HVAC Upgrade - Phase 3 - 1997

Conceptual Estimate

Net Floor Area (sf): 12,185
Date: 20-Nov-20

PHASE 3 - ESTIMATE SUMMARY

Description		\$/sf	Total
General Requirements			
01	General Requirements	0.86	10,480
Facility Construction			
02	Existing Conditions	0.36	4,414
03	Concrete		
04	Masonry		
05	Metals	0.25	3,000
07	Thermal and Moisture Protection	1.07	13,000
08	Openings		
09	Finishes	0.64	7,788
10	Specialties		
Facility Services			
23	Heating Ventilating and Air Conditioning	43.20	526,363
26	Electrical	0.90	11,010
Site and Infrastructure			
32	Exterior Improvements		
33	Utilities		
Sub-Total:		47.28	\$ 576,056
	Design & Pricing Contingency	10.00%	57,606
	Construction Contingency	3.00%	19,010
	Insurance (General Liability & Workers Compensation)	2.00%	13,053
	Performance and Payment Bond	1.00%	6,657
	General Conditions/Overhead/Profit	12.50%	84,048
	Escalation - by owner (depending on const start date)		<i>not included</i>
	Phasing premium	10.00%	75,643
Total Construction Cost:		68.29	\$ 832,072

**Hawley Elementary School
Newtown, CT
HVAC Upgrade - Phase 3 - 1997**

Conceptual Estimate

Net Floor Area (sf): 12,185

Date: 20-Nov-20

	Description	Quantity	Unit	Unit Cost	Total
GENERAL REQUIREMENTS					
01	GENERAL REQUIREMENTS				
	Temporary Facilities & Controls				
	Dust control (place & remove, cleanup, removal of demo'd materials), moving desks & chairs / floor protection	2,040	sf	2.00	4,080
	Dumpster, 4 pulls per month	1	mo	6,400.00	6,400
	Temporary Facilities & Controls				10,480
	TOTAL GENERAL REQUIREMENTS			\$	10,480
FACILITY CONSTRUCTION					
02	EXISTING CONDITIONS				
	Removal and Salvage of Construction Materials				
	Demo corridor ceilings for installation of, electrical wiring, duct, etc	607	sf	2.00	1,214
	Cutting block walls for new ductwork distribution across corridor	4	ea	500.00	2,000
	Core drilling of block walls for new piping/conduit distribution across corridor	4	ea	300.00	1,200
	Removal and Salvage of Construction Materials				4,414
	TOTAL EXISTING CONDITIONS			\$	4,414
05	METALS				
	Misc Metals				
	Misc metal angles at openings in floor & wall for new duct & pipe	1	alw	3,000.00	3,000
	Misc Metals				3,000
	TOTAL METALS			\$	3,000
07	THERMAL and MOISTURE PROTECTION				
	Roofing				
	Temporary roof protection/walkways for removal of exist 1997 RTUs & installation of new RTUs	1	alw	10,000.00	10,000
	Roof patching/flashings after installation of curb adaptors for replaced RTUs in 1997 area	6	ea	500.00	3,000
	Roofing				13,000
	TOTAL THERMAL and MOISTURE PROTECTION			\$	13,000
09	FINISHES				
	Ceilings				
	FULL - replace demo'd T-bar ceiling grid & tiles for installation of ductwork, control wiring, electrical wiring, etc	607	sf	6.50	3,946
	PARTIAL - Remove & replace T-bar ceiling tiles for installation of ductwork, control wiring, electrical wiring, etc	351	sf	3.50	1,229
	Replace 25% of removed ceiling tiles due to breakage after removal for HVAC upgrade	88	sf	3.50	307
	Replace 25% of T-bar ceiling grid damaged during HVAC upgrade and/or for installation of ductwork	88	sf	3.50	307
	Ceilings				5,788

Hawley Elementary School
Newtown, CT
HVAC Upgrade - Phase 3 - 1997

Conceptual Estimate

Net Floor Area (sf): 12,185

Date: 20-Nov-20

Description		Quantity	Unit	Unit Cost	Total
Painting and Coatings					
Allowance for touch up of wall/surface areas damaged during HVAC upgrade		1	alw	2,000.00	2,000
Painting and Coatings					2,000
TOTAL FINISHES					\$ 7,788
FACILITY SERVICES					
23 HEATING VENTILATING and AIR CONDITIONING					
Heating					
Existing heating water plant, pumps, exp tanks, air separators, piping, perimeter finned tube radiation, etc					<i>ETR</i>
Connect to exist heating water lines		2	ea	453.56	907
Heating water piping, 3/4" dia (for VAV box reheat coils)		250	lf	28.10	7,025
Local heating water piping rough-in & conn at VAV box reheat coil		3	ea	1,407.84	4,224
Valves & specialties (thermometers, pressure gauges, test fittings, air vents, flex pipe conns, access panels, drain pans, backflow preventors)		1	ls	1,100.00	1,100
Pipe insulation, 1 1/2" thick, 3/4" dia (for VAV box rhc)		250	lf	11.06	2,765
Heating					16,021
Air Distribution					
Demo exist 1997 wing RTU & replace with new pkg DX cooled RTU w/energy recovery wheel & curb adaptor (6 ea, total 20,250 cfm)		1	ls	198,850.00	198,850
Bi-polar ionization units					<i>not included</i>
Sound attenuators for RTU supply/return ducts		40,500	cfm	0.50	20,250
VAV box w/hot water reheat coil (for 1997 area A Science Classroom & Lobby/Corridor)		3	ea	1,164.22	3,493
Ductwork, insulation, air outlets, dampers, flex duct, etc for Science Classroom and Lobby/Corridor VAV boxes		1	alw	33,700.00	33,700
Clean (50%), pressure test (50%) & reseal (10%) of existing to remain ducts in 1997 areas		1	alw	10,000.00	10,000
HVAC systems for boiler & elec rooms - to remain as is					<i>ETR</i>
Air Distribution					266,293
Testing, Adjusting, and Balancing for HVAC					
Testing, adjusting & balancing air & (new) water systems		150	hrs	105.00	15,750
Testing, Adjusting, and Balancing for HVAC					15,750
Controls					
DDC BAS system budget provided by ABS-DDC		1	ls	167,000.00	167,000
Controls					167,000

**Hawley Elementary School
Newtown, CT
HVAC Upgrade - Phase 3 - 1997**

Conceptual Estimate

Net Floor Area (sf): 12,185

Date: 20-Nov-20

Description		Quantity	Unit	Unit Cost	Total
Miscellaneous HVAC					
Firesafing (at new penetrations only)		1	alw	2,000.00	2,000
Coord & As-Builts (3% labor)		1	ls	7,100.00	7,100
Daily cleanup (3% labor)		1	ls	7,100.00	7,100
Small tools & consum (4% labor)		1	ls	9,400.00	9,400
Equip Rental (2% labor)		1	ls	4,700.00	4,700
Rigging/Cranes		1	ls	5,000.00	5,000
Startup (2% material)		1	ls	4,700.00	4,700
Warranty (0.5% material & labor)		1	ls	2,400.00	2,400
Supervision (8% labor)		1	ls	18,900.00	18,900
Miscellaneous HVAC					61,300
TOTAL HEATING VENTILATING and AIR CONDITIONING				\$	526,363
26 ELECTRICAL					
Cabling, Conductors, Raceway					
Disconnect existing RTU, leave feeder for re-use		6	ea	100.00	600
Connect new RTU to existing feeder, provide new safety switch		6	ea	700.00	4,200
Remove light fixts in demo'd ceilings & later reinstall in new ceilings		14	ea	415.00	5,810
Remove, temporarily support & replace exist cameras, speakers, FA devices, WAPs, etc, mounted in ceiling, for removal & replacement of ceiling tiles/grid to allow installation of ductwork, electrical wiring		8	ea	50.00	400
Cabling, Conductors, Raceway					11,010
TOTAL ELECTRICAL				\$	11,010



CHRISTOPHER WILLIAMS ARCHITECTS LLC

Hawley School Meeting PBSC Meeting Agenda

Meeting Date **November 24, 2020**

CWA TEAM:

Christopher Williams CWA

Ilona Prosol, BVH

John Luby, Enviro-med.

1. **Testing:** Enviro-med is scheduled to perform the second IAQ study on the week of December 7, 2020, which is a postponement from the scheduled date due to distance learning.
2. **Meeting Notes, 11/3/20:** On 11/03/20, a zoom meeting was held with:
 - Bob Gerbert (Town of Newtown)
 - Allen Adriani (Town of Newtown)
 - Christopher Williams (CWA)
 - Ilona Prosol (BVH)
 - Jeremy Rapoza (BVH)
 - Josiah Butler (BVH)
 - 2.1. Items discussed:
 - 2.1.1. The Town is concerned that the VRF system will result in a series of individual units throughout the building that rely on a refrigerant that will be phased out of production in 2024, resulting in excessive refrigerant replenishment costs afterwards and possible complicated replacement work when the units become obsolete in the future.
 - 2.1.2. Design parameters were reviewed, and it was agreed that equipment should be sized per ASHRAE/IMC ventilation rates.
 - 2.1.3. The increase in ductwork size will necessitate additional suspended ceiling modifications and/or additions. The Town agreed, especially in the 1921 building that has high ceilings with poor acoustics.
 - 2.1.4. The Town reiterated the preference to design a VAV type system.
 - 2.1.5. The Town requested that a conceptual estimate be prepared by 11/6/20 for the next finance committee meeting.
3. **Conceptual Estimate no. 1, 11/6/20:**
 - 3.1. 11/6/20 Estimate: CWA presented an estimate totaling \$6,313,595.00. This was based on a VRF system proposed by BVH. An additional Rough Order of Magnitude (ROM) cost of \$1,000,00 was identified to upgrade the system to a VAV system. The additional costs would be attributed to:
 - 3.1.1. Larger ductwork required to handle the increased volume of air.
 - 3.1.2. Changing refrigerant piping to hot water supply and return piping.
 - 3.1.3. Increase in spatial requirements to accommodate larger ductwork and VAV units throughout the building.
 - 3.1.4. Increase in outdoor air, resulting in additional louvers.
 - 3.1.5. Additional suspended ceilings being removed/replaced and added throughout the building.
4. **Meeting Notes, 11/13/20:** On 11/03/20, a zoom meeting was held with:
 - Bob Gerbert (Town of Newtown)
 - Allen Adriani (Town of Newtown)



CHRISTOPHER WILLIAMS ARCHITECTS LLC

Gordon Johnson (Town of Newtown)
Christopher Williams (CWA)
Ilona Prosol (BVH)
Jeremy Rapoza (BVH)

4.1. Items Discussed:

- 4.1.1. Budget: The \$6.3 - \$7.3 million estimate exceeds the Town's initial \$4.1 Million estimate.
- 4.1.2. The Town will consider phasing the project into three phases roughly reflecting the vintage of each building wing-1921, 1948 and 1997.
- 4.1.3. The design team expressed concern over phasing and performing the work during school breaks, which would be 2 months during the summer and a few weeks during the school year. The work cannot reasonably be completed in those time periods, especially if a more extensive ducted system is deployed. The town needs to develop temporary plans for the classes held in the affected rooms.
- 4.1.4. The design team recommends that the Town engage a Construction Manager/Owner's Rep who can assist in developing logistic plans, identify swing spaces, develop independent cost estimates and offer funding/budgeting guidance on ancillary but necessary non-construction expenses.
- 4.1.5. The design team was asked to develop a phased Conceptual Estimate by 11/20/20.

5. Conceptual Estimate no. 2, 11/20/20:

- 5.1. The attached Conceptual Estimate is divided into 3 phases totaling \$7,268,537.00.
- 5.2. In addition to the estimate, attached are phasing floor plans:
 - 5.2.1. Phase 1: 1921 Building
 - 5.2.2. Phase 2: 1948 Building and part of the 1995 Building. The central corridor of the 1948 building extends into the 1995 building and including it with the 1948 building is a logical choice. The 1995 lobby/corridor that extends beyond the classrooms would not be included in phase 2, so corridor bi-directional doors may be considered to keep the atmospheres separate.
 - 5.2.3. Phase 3: Replacing/upgrading the 1995 building Rooftop units, including extending the system into Science Classroom M100 and the lobby/corridor.

6. Design Progress: The design team has developed progress plans sufficient for the cost estimator to develop the attached budget. Between actual drawings, take-offs from the BIM model, narratives and discussions, the scope is sufficiently captured in the budget. As with most conceptual budgets, some items may be high in cost and some low but will level off as the accuracy of design and pricing increases.

- 6.1. To move forward into Design Development, the design team needs direction on the budget from the Town.

Attachments as Separate Files:

Conceptual Estimate, dated 20-Nov-20 prepared by MEP Cost LLC
G001-Phasing Plans-dated 11.20.20 prepared by CWA
Progress Drawing Set-dated 11.20.20 by CWA and BVH

Hawley Elementary School
HVAC Improvements

-Split project into separate phases

Phase I – 1921 Section

Phase II – 1948 Section

-Phase I work scope

-Perform work using current funding on CIP

-Ducted VAV air distribution for 1921 portion of building

-Electrical service upgrade to facilitate Phase I and Phase II work

-Ceiling/lighting in classrooms, hallways, etc.

-HVAC controls

-Phase II work scope

-Add project/funding to CIP in 2021 for FY 2024/25

-Ducted VAV air distribution for 1948 portion of building

-Ceiling/lighting in classrooms, hallways, etc.

-Phase I work split into two summers 2021 & 2022

Summer 2021

-Electric service upgrade

-Hazmat abatement

-HVAC unit prep work (i.e equipment pads)

-Structural modifications/prep work

-Roofing modification/prep work

Summer 2022

-HVAC unit installation

-Ductwork/VAV installation

-Heating pipe installation

-Ceiling/lighting installation

-Phase II work

Summer 2023

-HVAC unit prep work (roof curbs)

-Structural modifications/prep work

-Roofing modifications/prep work

-Hazmat abatement

Summer 2024

-HVAC unit installation


-Ductwork/VAV installation

-Heating pipe installation

-Ceiling/lighting installation

Phase I


Phase II

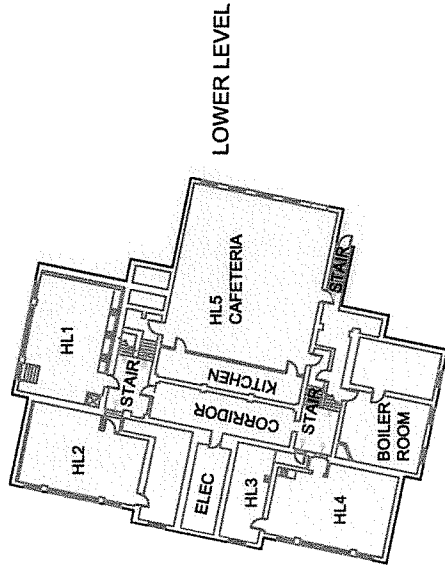


LOWER LEVEL

1921


1ST FLOOR LEVEL

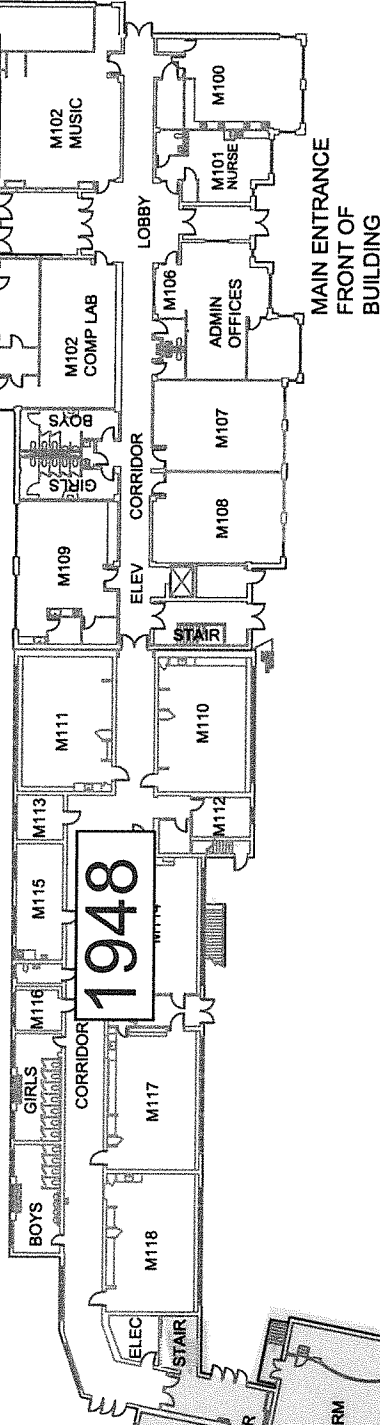

FACING CHURCH
HILL ROAD

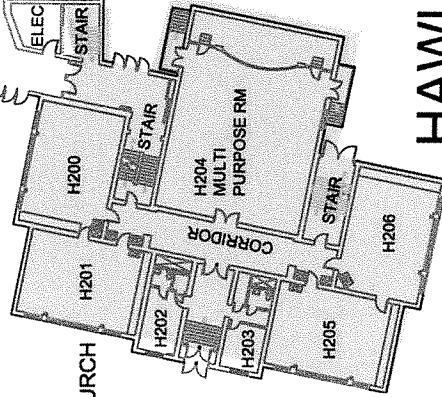


HAWLEY ELEMENTARY SCHOOL-1ST AND LL FLOOR PLAN

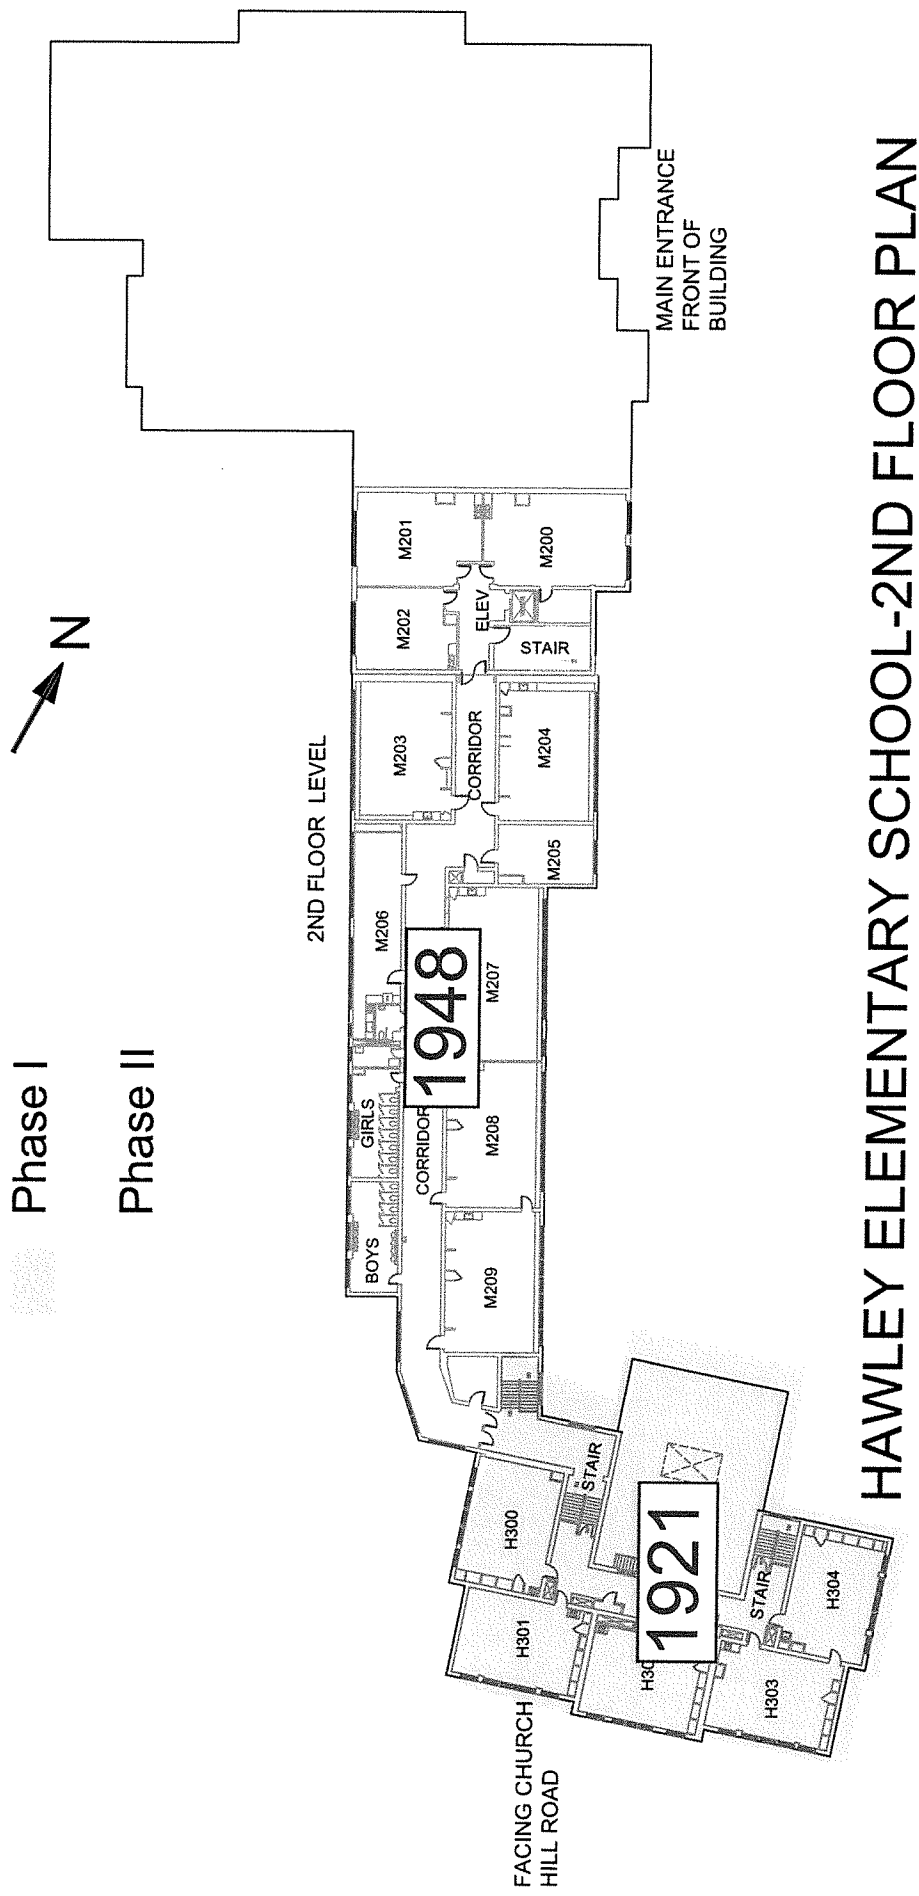


HAWLEY ELEMENTARY SCHOOL-2ND FLOOR PLAN

GENERAL NOTES

1. The intent of the Contract Documents is to provide a framework for the proper execution and completion of all Work. The Contractor shall be responsible for obtaining all necessary permits, licenses, and approvals from the appropriate authorities. The Contractor shall be responsible for obtaining all necessary permits, licenses, and approvals from the appropriate authorities. The Contractor shall be responsible for obtaining all necessary permits, licenses, and approvals from the appropriate authorities.
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3. The Contractor shall be responsible for obtaining all necessary permits, licenses, and approvals from the appropriate authorities. The Contractor shall be responsible for obtaining all necessary permits, licenses, and approvals from the appropriate authorities. The Contractor shall be responsible for obtaining all necessary permits, licenses, and approvals from the appropriate authorities.
4. This is an existing building. All conditions and circumstances shall be as shown.

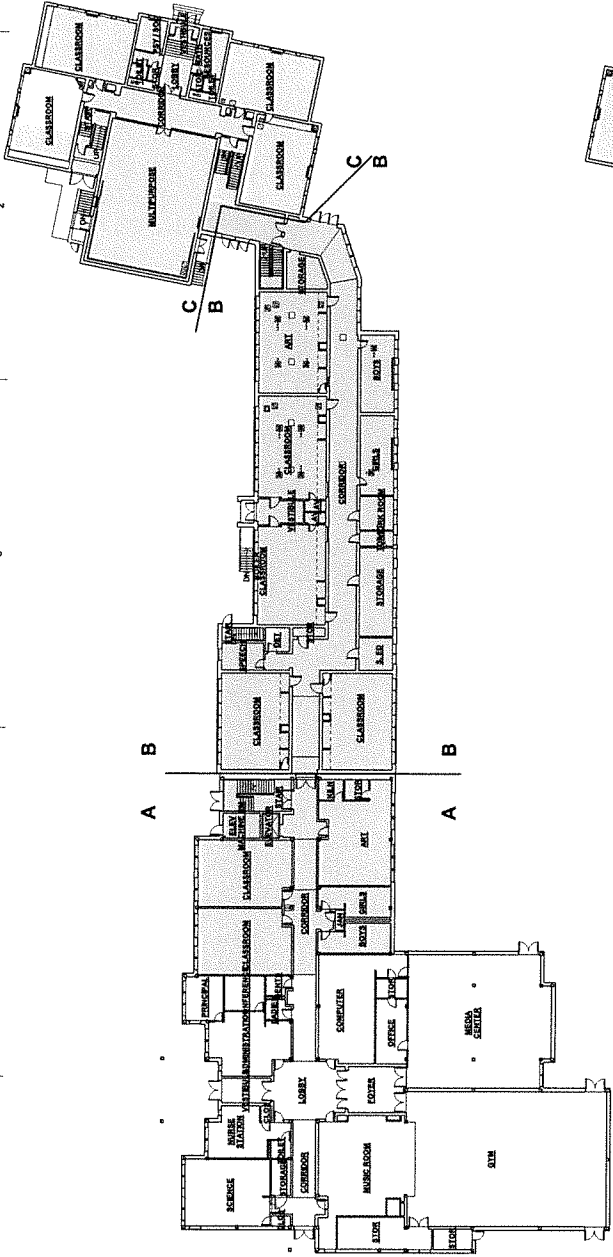

B5 FIRST FLOOR PLAN - PHASE
1" = 20'-0"

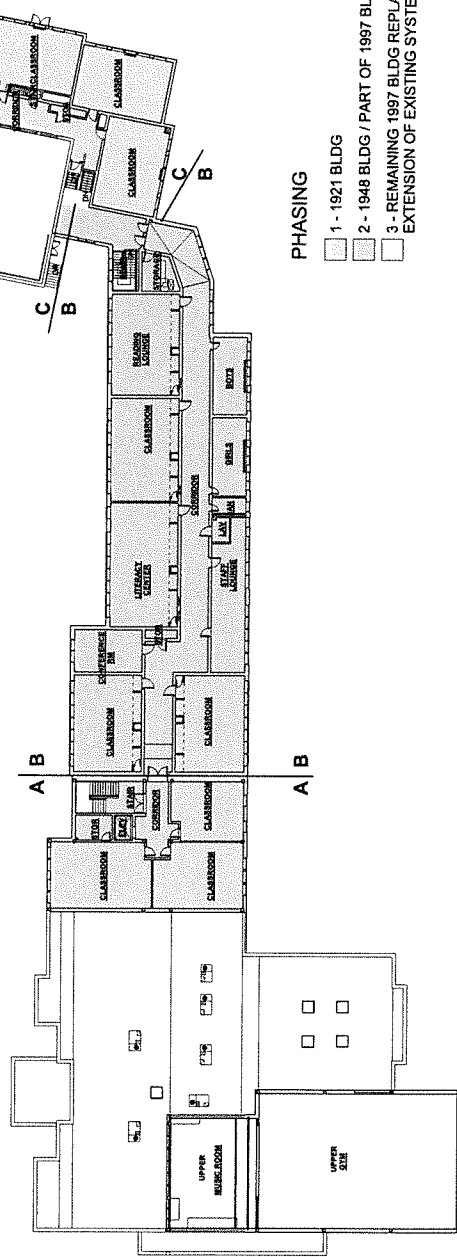

A5 SECOND FLOOR PLAN - PHASE
1" = 20'-0"

PHASING

- 1 - 1921 BLDG
- 2 - 1948 BLDG / PART OF 1997 BLDG
- 3 - REMAINING 1997 BLDG REPLACEMENT & EXTENSION OF EXISTING SYSTEM



HAWLEY ELEMENTARY SCHOOL
NEW MILFORD, CT 06455

CWA
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203 WILSON ST.
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BVH
Integrated SERVICES
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New Milford, CT 06455
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EnviroMed
ENVIRONMENTAL CONSULTANTS
215 W. MAIN STREET, SUITE 200
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PROGRESS DRAWINGS
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CWA PROJECT NO. 2013		
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PHASING

G001




CWA PROJECT NO.: 2013

HAWLEY ELEMENTARY SCHOOL

29 CHURCH HILL ROAD
NEWTOWN, CT 06470

SHEET INDEX			ISSUE 1
NO.	SHEET NAME	DATE	
G001	PHASING		
AE101	SITE PLAN		
AE102	OVERALL EXISTING FIRST FLOOR PLAN		
AE103	OVERALL EXISTING SECOND FLOOR PLAN		
AE111	OVERALL EXISTING FIRST FLOOR RCP		
AE112	OVERALL EXISTING SECOND FLOOR RCP		
AE201	EXTERIOR ELEVATIONS		
AE202	EXTERIOR ELEVATIONS		
AE301	BUILDING SECTIONS - AREA A		
AE302	BUILDING SECTIONS - AREA B		
AE303	BUILDING SECTIONS - AREA C		
AE310	BUILDING SECTIONS - AREA A		
AE311	WALL SECTIONS - AREA A		
AE312	WALL SECTIONS - AREA B		
AE313	WALL SECTIONS - AREA C		
AE314	WALL SECTIONS - AREA A/B JOINT		
AE315	OVERALL FIRST FLOOR PLAN		
AE316	OVERALL SECOND FLOOR PLAN		
AE317	OVERALL FIRST FLOOR RCP		
AE318	OVERALL SECOND FLOOR RCP		
AE319	FIRST FLOOR PLAN AREA C		
AE320	SECOND FLOOR PLAN AREA C		
AE321	ATTIC PLAN AREA C		
AE322	EXTERIOR ELEVATIONS		
AE323	EXTERIOR ELEVATIONS		
AE324	ELEVATION AREA C		
AE325	SECTION - AREA C LOWER		
AE326	WALL DETAILS		
AE327	SCHEDULES		
AE328	SCHEDULES		
AE329	WALL JOINT PLAN		
AE330	HVAC FIRST FLOOR PLAN		
AE331	HVAC SECOND FLOOR PLAN		
AE332	HVAC FIRST FLOOR PLAN AREA A		
AE333	HVAC SECOND FLOOR PLAN AREA A		
AE334	HVAC FIRST FLOOR PLAN AREA B		
AE335	HVAC SECOND FLOOR PLAN AREA B		
AE336	HVAC FIRST FLOOR PLAN AREA C		
AE337	HVAC SECOND FLOOR PLAN AREA C		
AE338	HVAC ROOF PLAN AREA A		
AE339	HVAC ROOF PLAN AREA B		
AE340	HVAC ROOF PLAN AREA C		

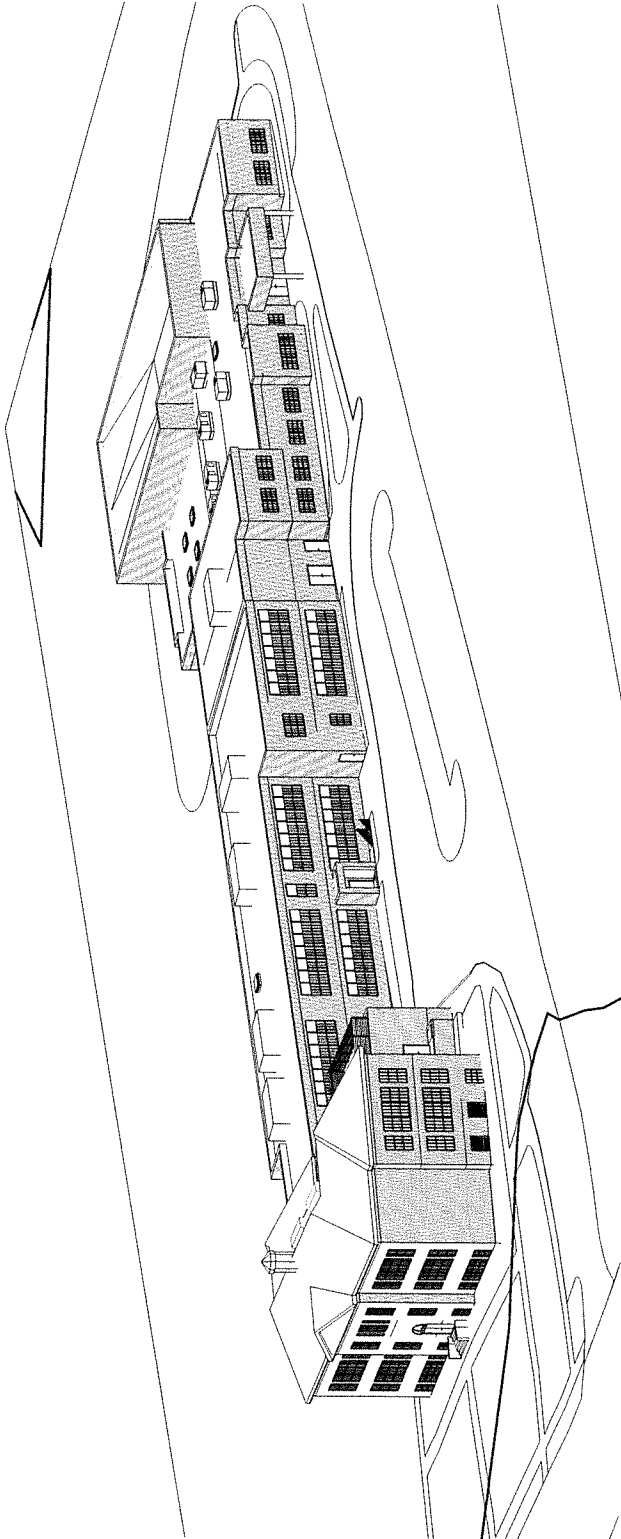

PROGRESS DRAWINGS
11/20/2020



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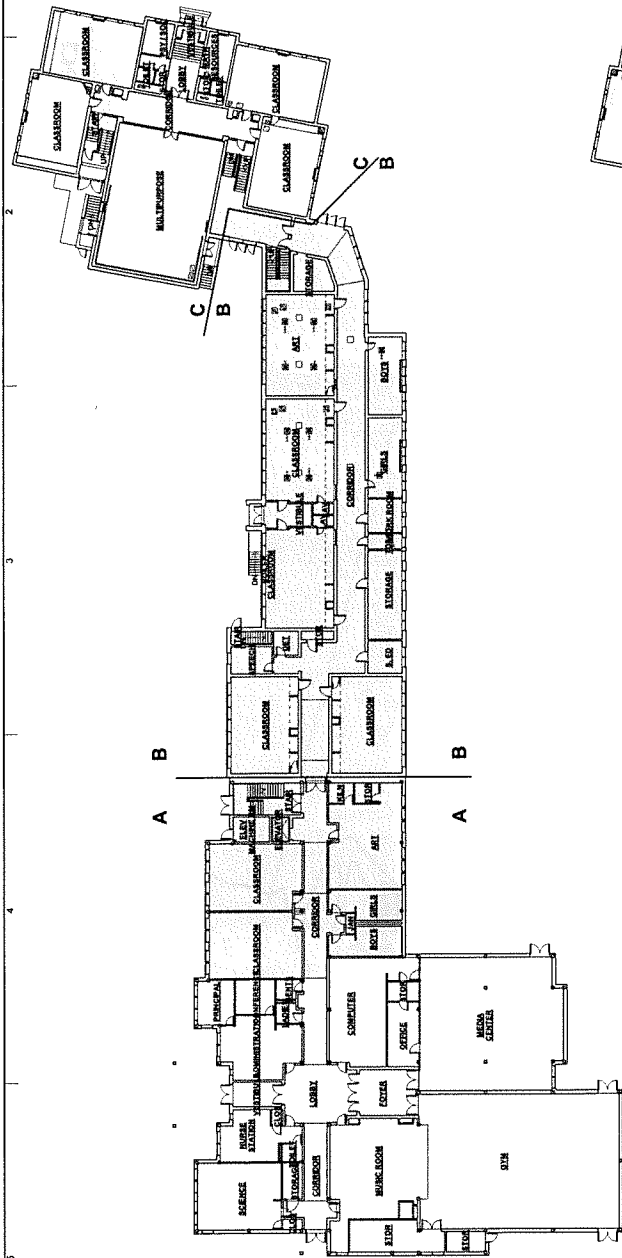
DESIGNED BY: JAMES J. JONES
CT ARCHITECTURAL PROJECTS, INC. 118
CT LAND PLANNING PROJECTS, INC. 118




CHRISTOPHER WILLIAMS ARCHITECTS, LLC
95 Willow Street
Newtown, CT 06451
203.778.0180
www.cwaarchitect.com

GENERAL NOTES

1. The intent of the Contract Documents is to include all items necessary for the proper installation and completion of all work. The Contractor shall be responsible for obtaining all necessary permits, licenses, and approvals required by the local, state, and federal authorities. The Contractor shall provide the Architect with all necessary information to obtain the required permits, licenses, and approvals. The Contractor shall be responsible for obtaining all necessary permits, licenses, and approvals. The Contractor shall provide the Architect with all necessary information to obtain the required permits, licenses, and approvals.
2. REFERENCE KEY NOTES AND SHEET KEY NOTES are provided to indicate and clarify the extent and requirements of the work. The Contractor shall be responsible for obtaining all necessary permits, licenses, and approvals. The Contractor shall provide the Architect with all necessary information to obtain the required permits, licenses, and approvals.
3. Do not locate storage, except for extension and appropriation purposes.
4. Do not locate storage, except for extension and appropriation purposes.



B5 FIRST FLOOR PLAN - PHASE

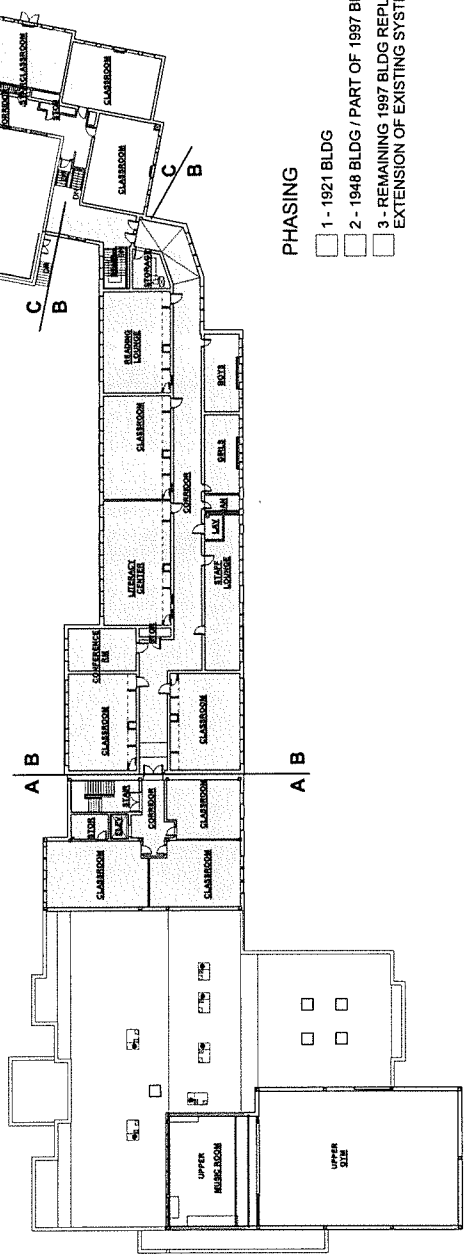

A5 SECOND FLOOR PLAN - PHASE

- PHASING**
- ☐ 1 - 1921 BLDG
 - ☐ 2 - 1948 BLDG / PART OF 1997 BLDG
 - ☐ 3 - REMAINING 1997 BLDG REPLACEMENT & EXTENSION OF EXISTING SYSTEM



		HAWLEY ELEMENTARY SCHOOL 25 CHURCH HILL ROAD NEW BRITAIN, CT 06053				CONTRACTOR CWA 25 CHURCH HILL ROAD NEW BRITAIN, CT 06053 203.778.5184 www.cwa-nb.com				ENGINEER BMH 200 West Main Street Bloomfield, CT 06002 Tel: (860) 286-9171 www.bmh.com				ENVIRONMENTAL CONSULTANT EnviroMed 100 Main Street Bloomfield, CT 06002 Tel: (860) 286-9171 www.enviro-med.com		PROGRESS DRAWINGS 11/20/2020		MARKS DATE DESCRIPTION PROJECT NO. DRAWING NO. SHEET NO. SHEET TITLE		PHASING G001	
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www.enviromed.com

PROGRESS DRAWINGS


11/20/2020

NO.	DATE	DESCRIPTION
1	11/20/2020	EXISTING SITE PLAN

SITE PLAN

C101

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A5 EXISTING SITE PLAN
1" = 20'-0"

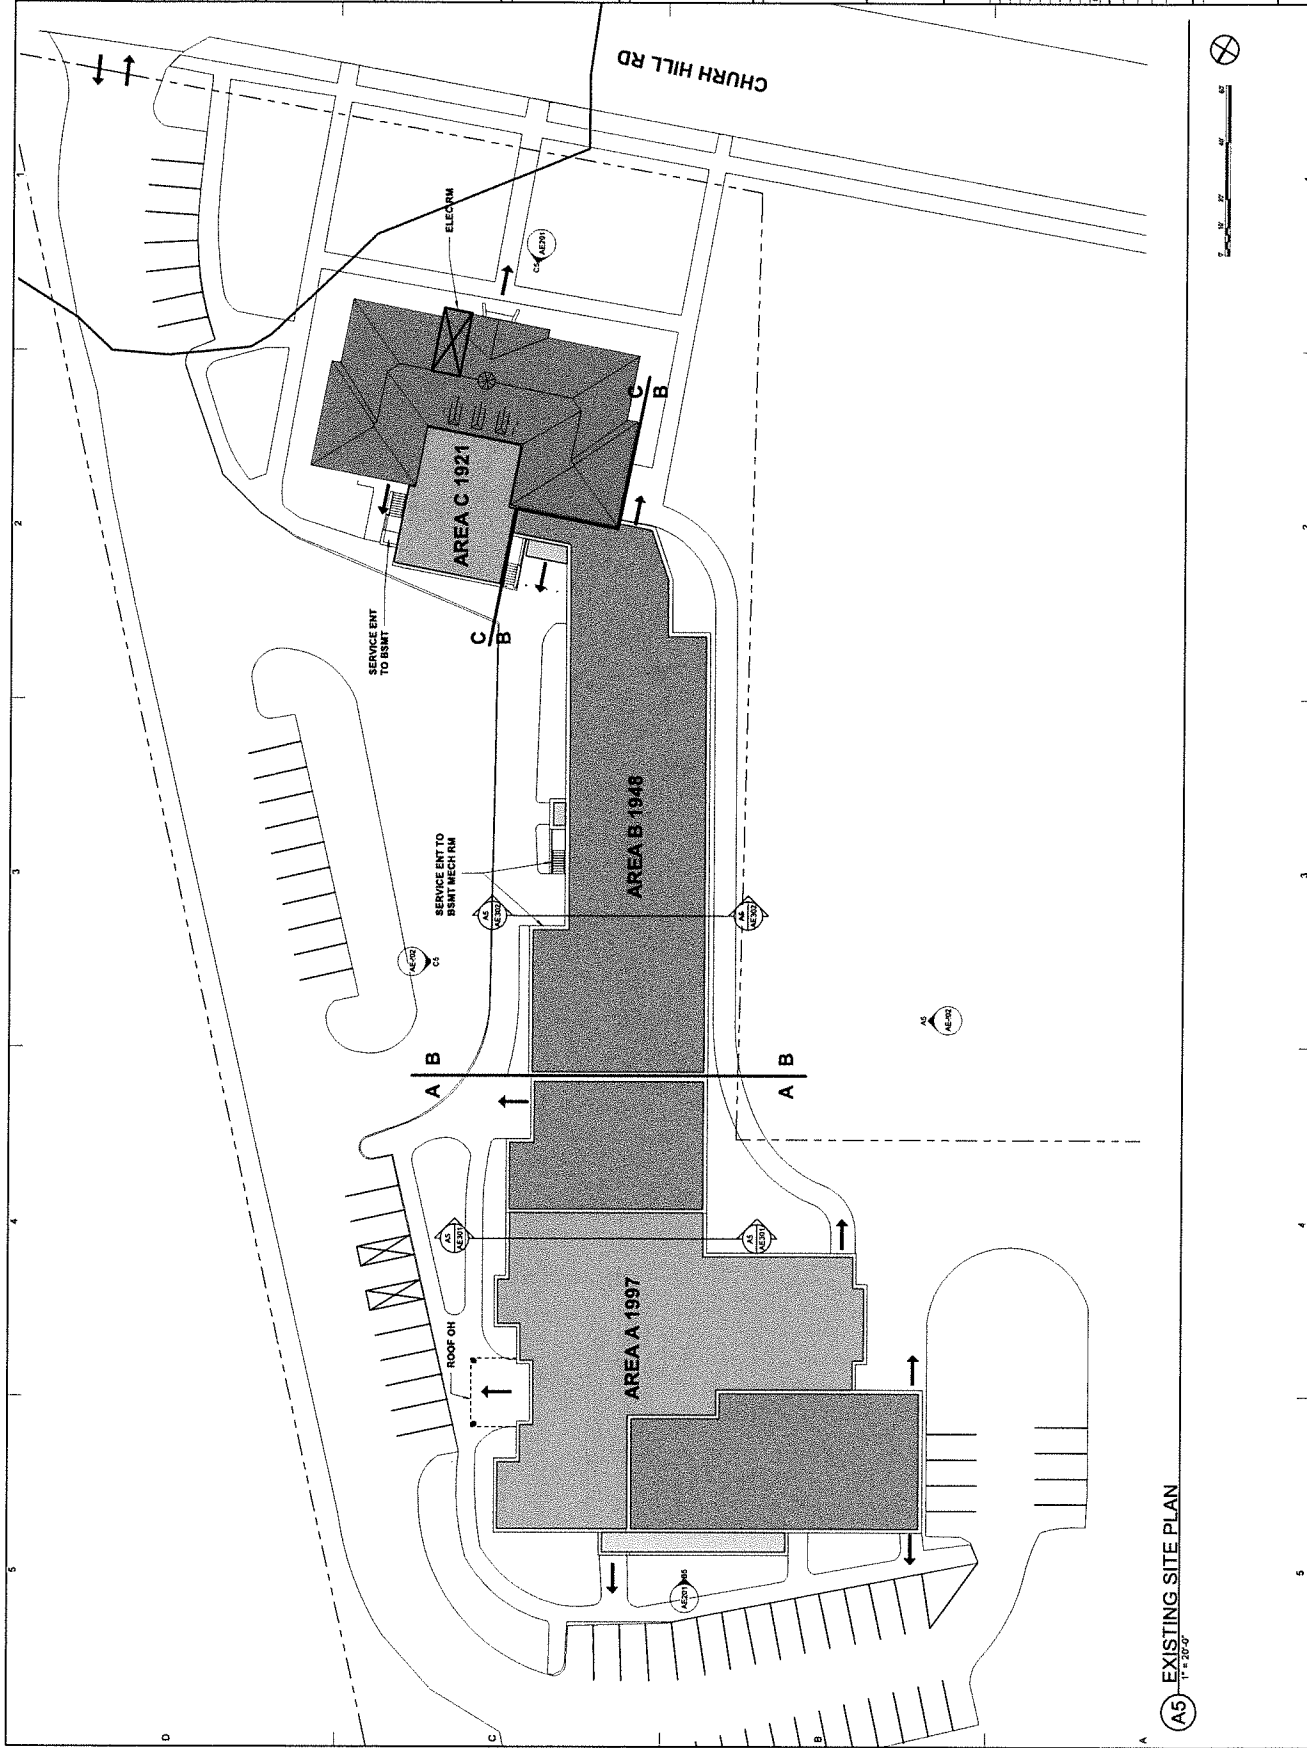

OWNER
**HAWLEY
ELEMENTARY
SCHOOL**
25 CHURCH HILL ROAD
NEW MILFORD, CT 06455



DESIGNER
CWA
CWA DESIGN VILLAGE ARCHITECTS, LLC
25 CHURCH HILL ROAD
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PROGRESS DRAWINGS


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SHEET TITLE
**OVERALL EXISTING
FIRST FLOOR PLAN**

AE101

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ROOMS
■ CURRENTLY AIR CONDITIONED

A5 EXISTING FIRST FLOOR PLAN - OVERALL
1/16" = 1'-0"

C5 EXISTING BASEMENT PLAN - OVERALL
1/16" = 1'-0"

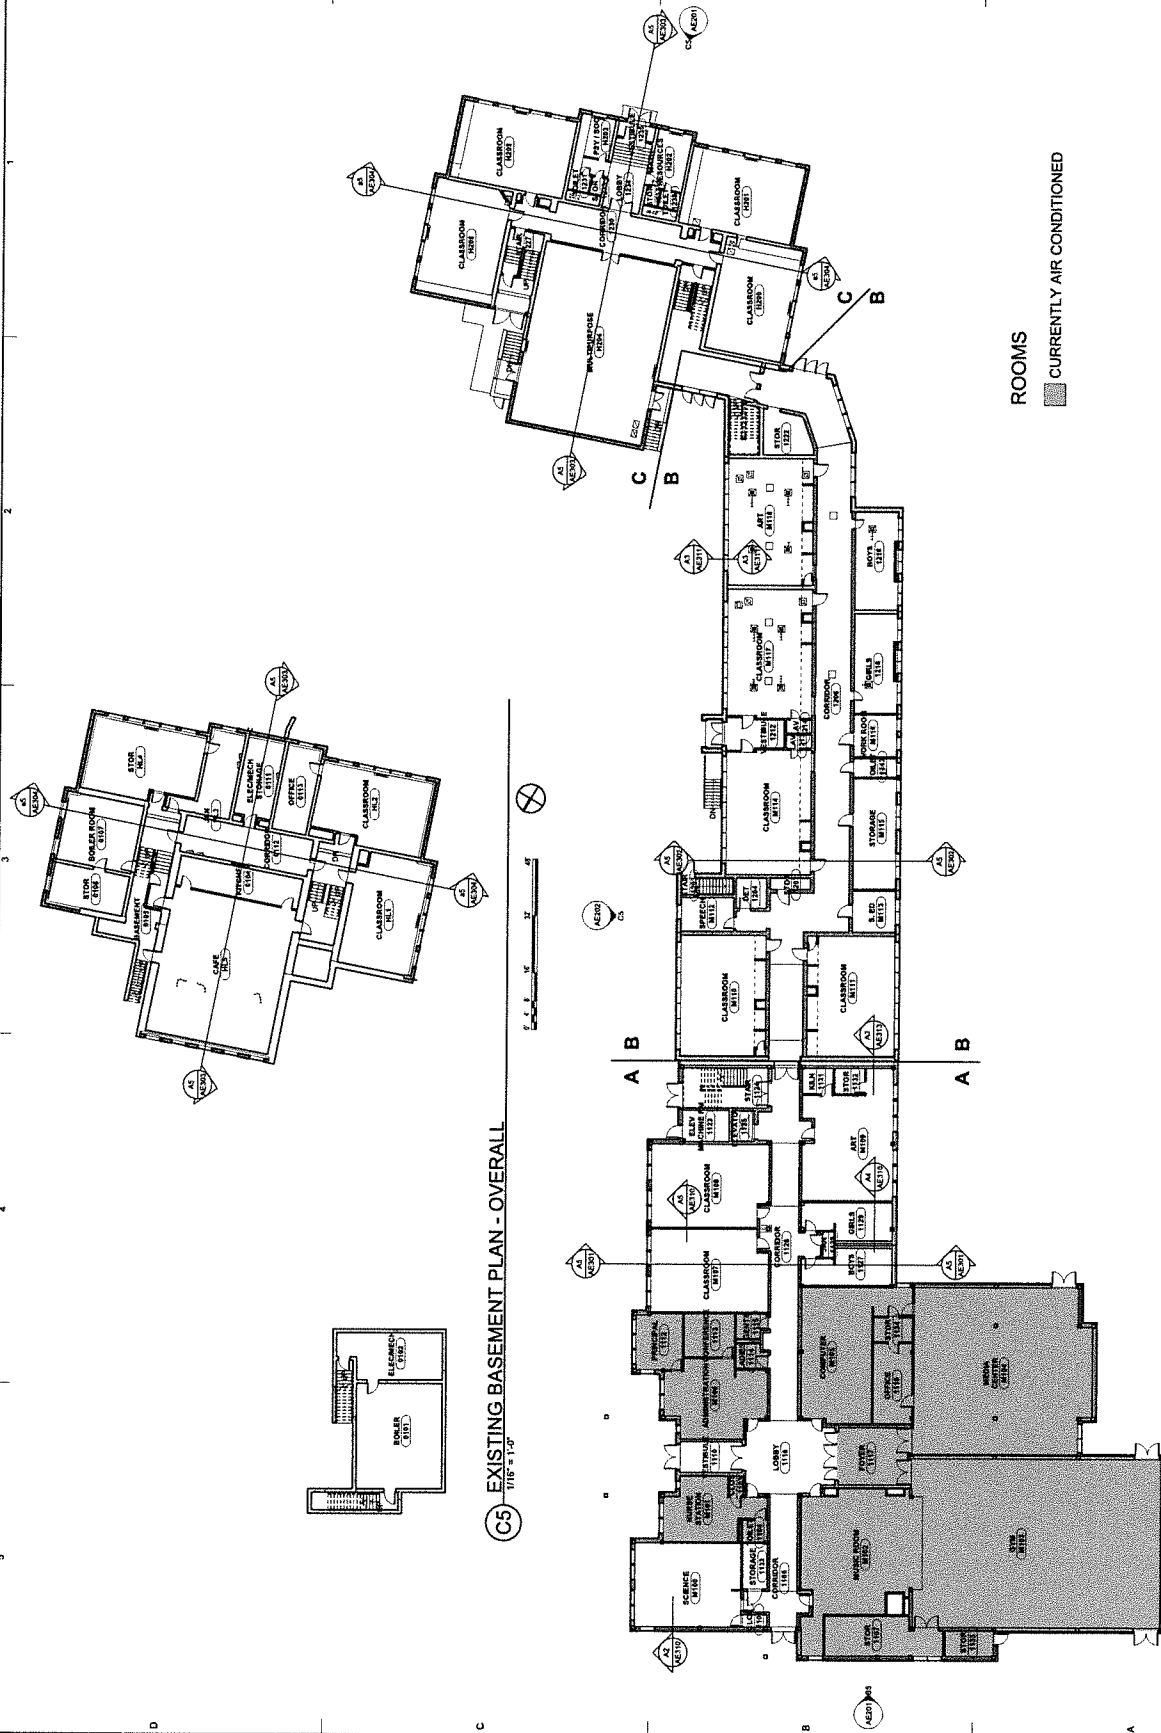

**HAWLEY
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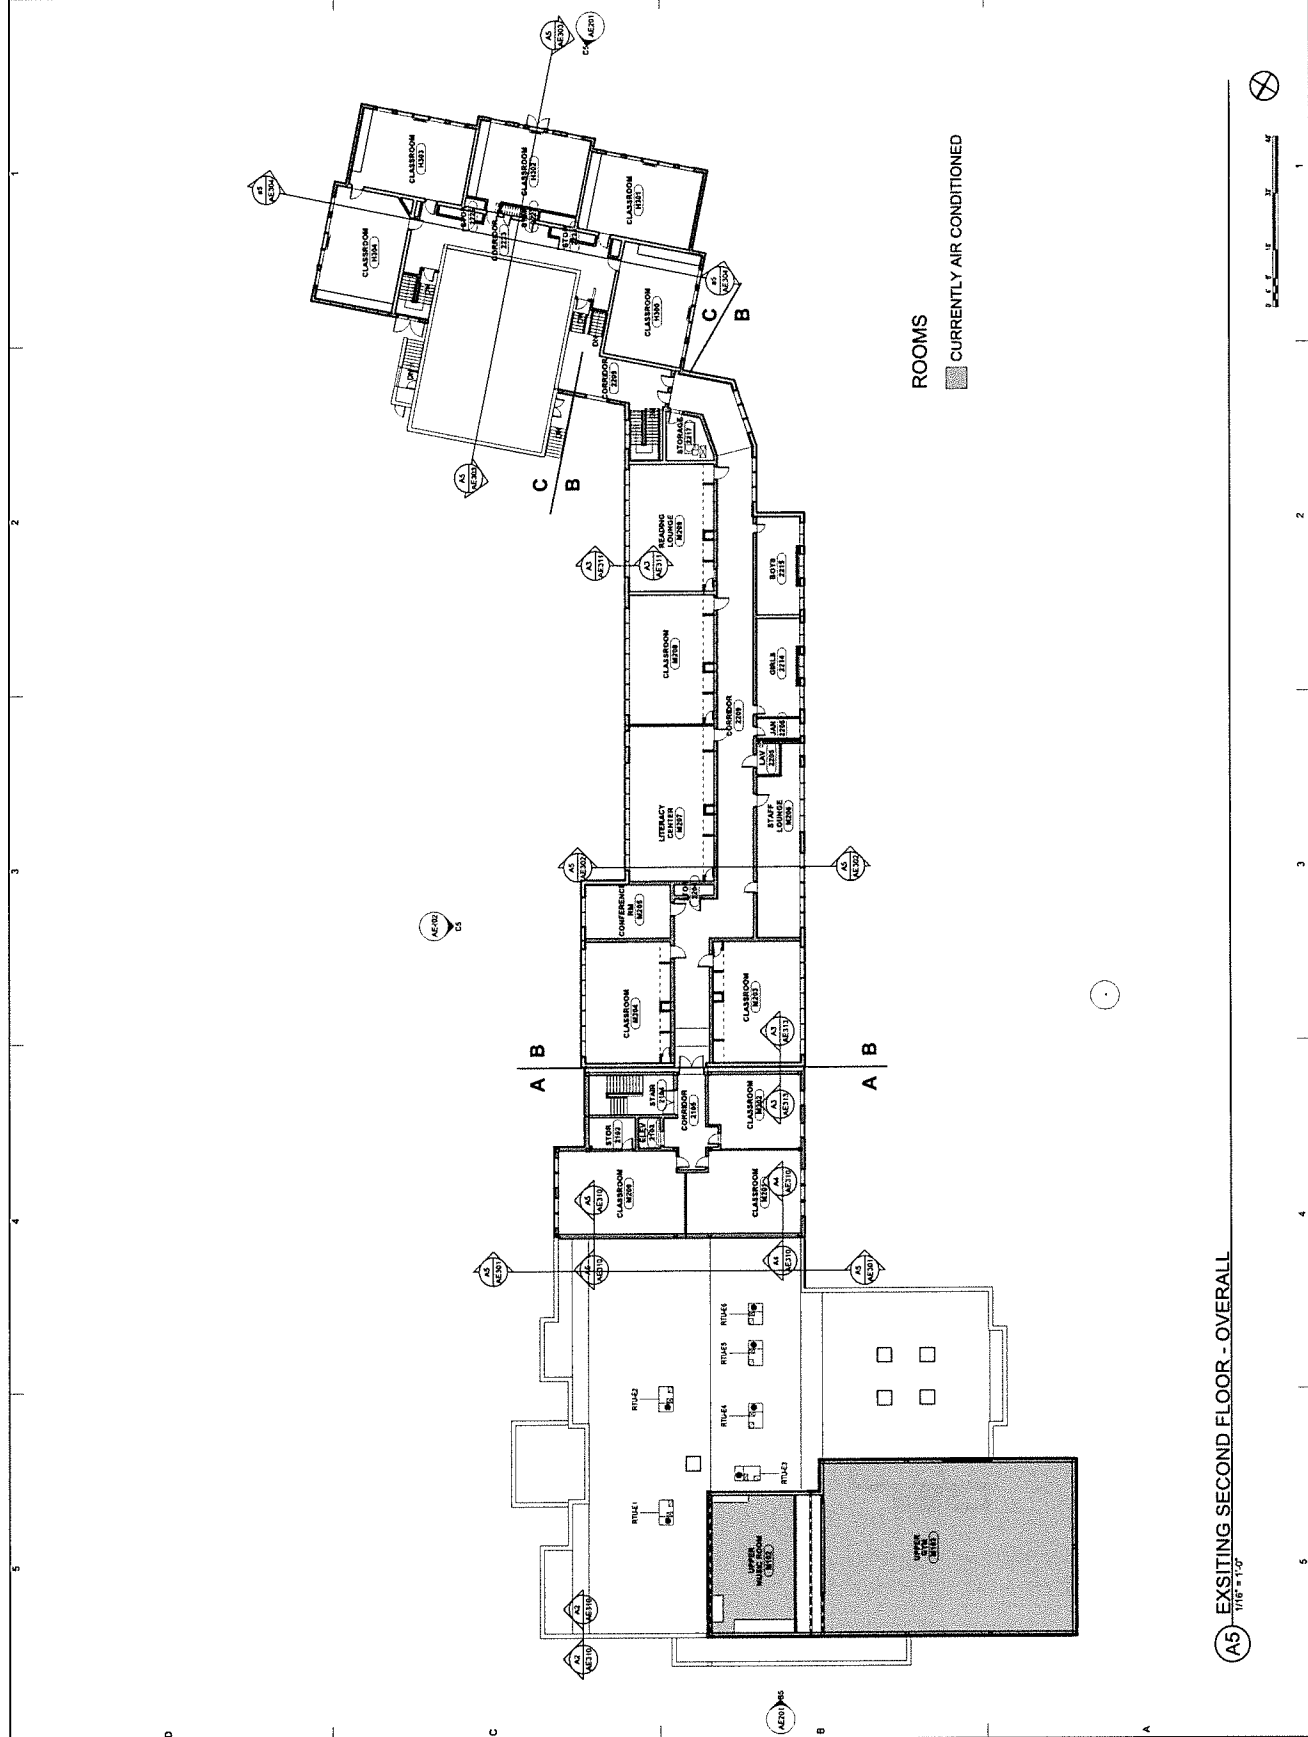
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SHEET TITLE
**OVERALL EXISTING
SECOND FLOOR PLAN**

AE102



A5 EXISTING SECOND FLOOR - OVERALL

11/20/2020



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24 CHURCH HILL ROAD
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100 WEST MAIN STREET, SUITE 200
MIDDLETOWN, CT 06450
203.776.5144
www.cwaarchitect.com


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Middletown, CT 06450
Tel: (860) 386-8171
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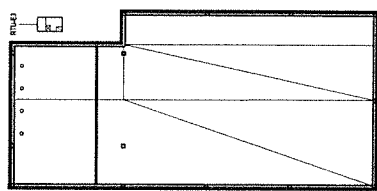
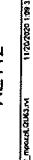
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PROGRESS DRAWINGS
11/20/2020

**OVERALL EXISTING
FIRST FLOOR RCP**

AE111



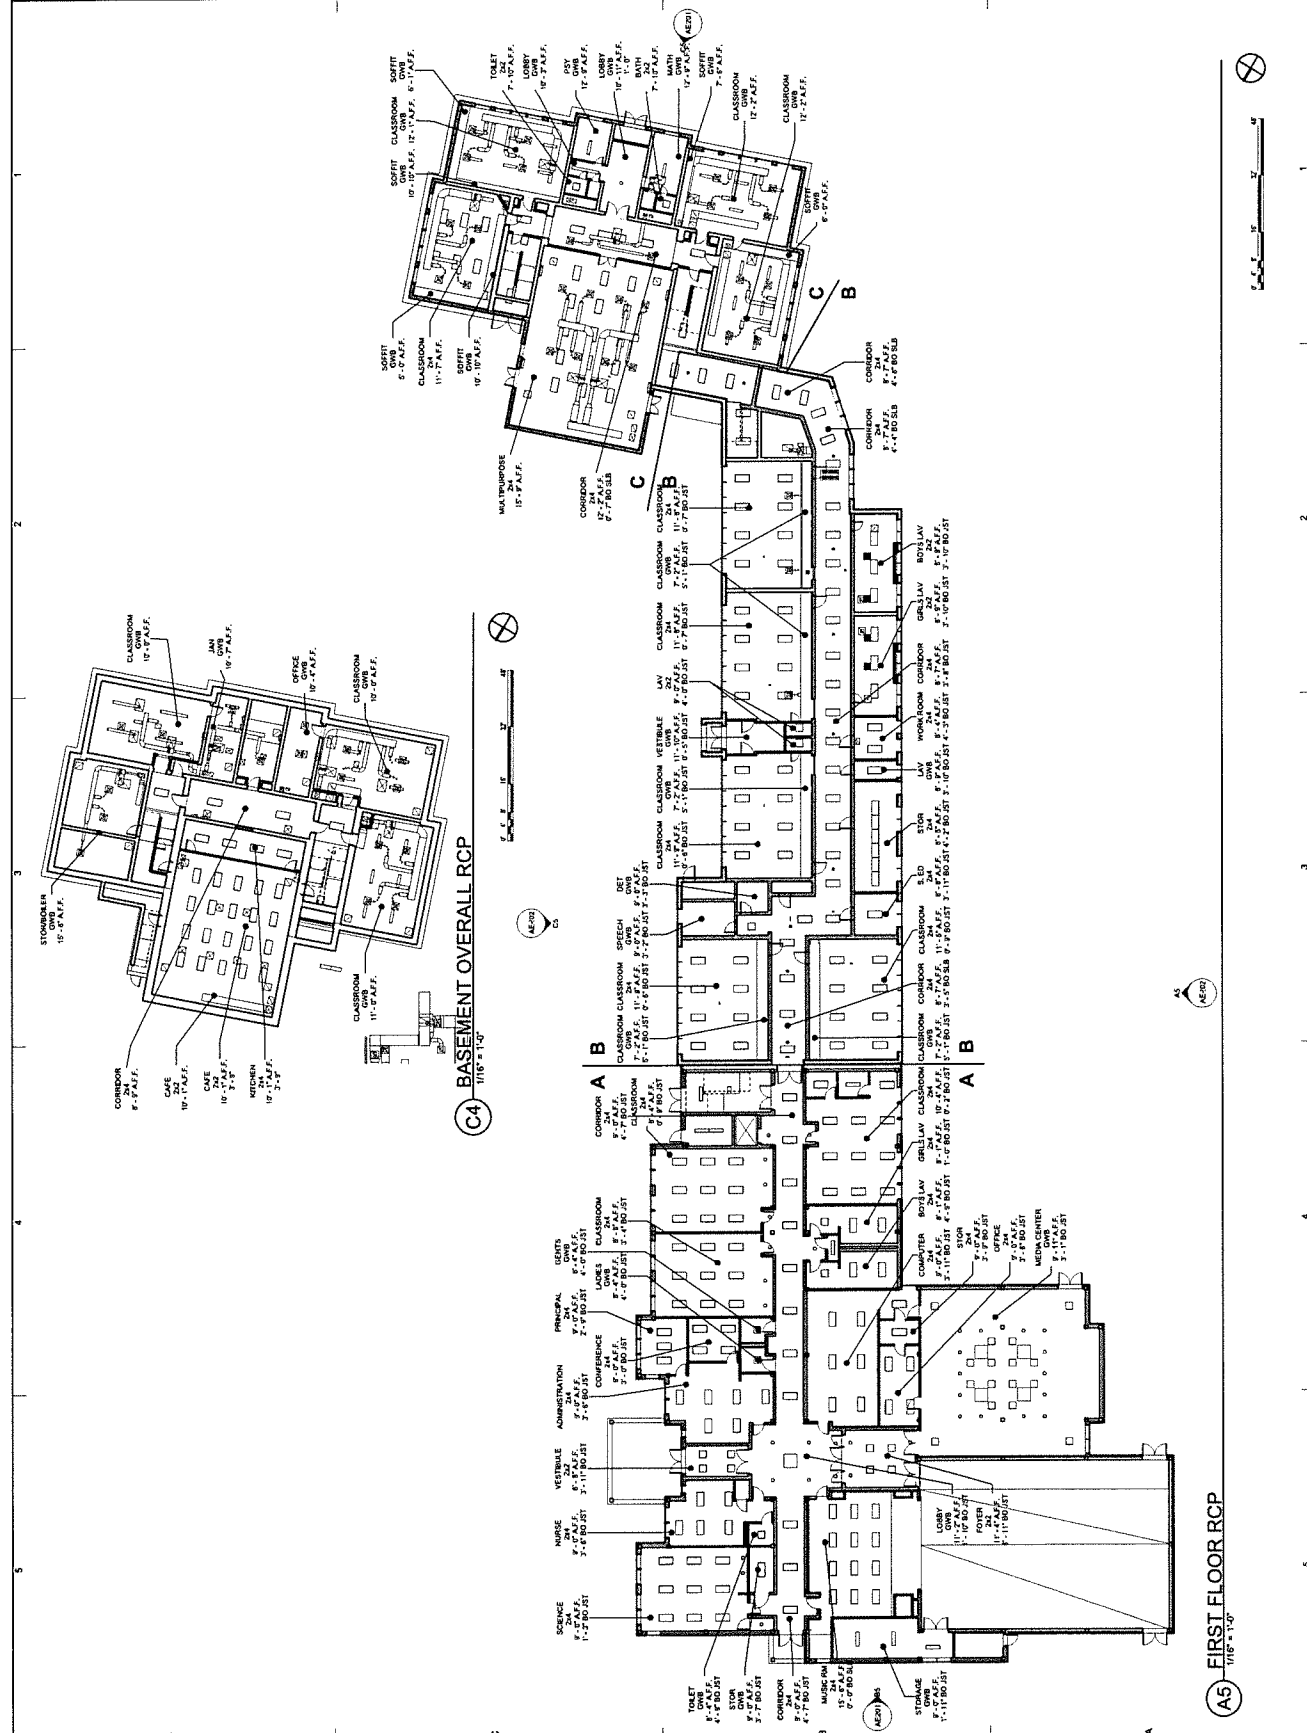

GENERAL NOTES

1. The intent of the General Conditions is to include all items necessary for the proper execution and completion of all Work in the Contract. The Contractor shall be responsible for obtaining all necessary permits and approvals from the appropriate authorities. The Contractor shall be responsible for obtaining all necessary permits and approvals from the appropriate authorities. The Contractor shall be responsible for obtaining all necessary permits and approvals from the appropriate authorities.
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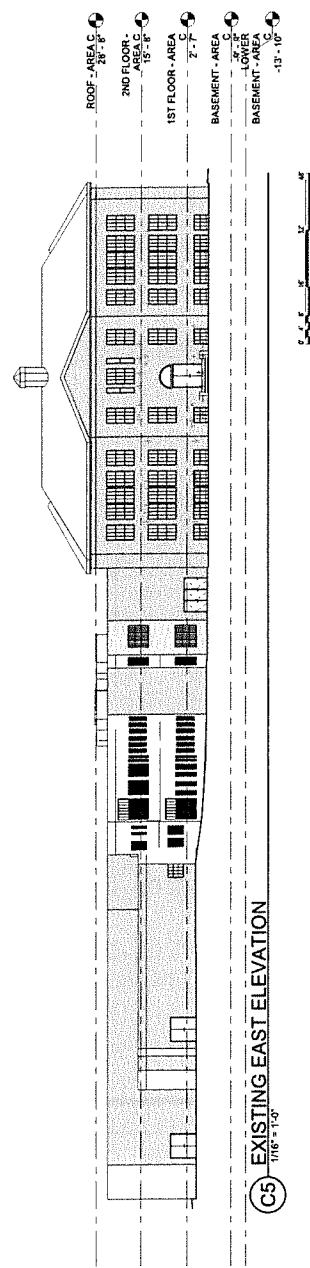
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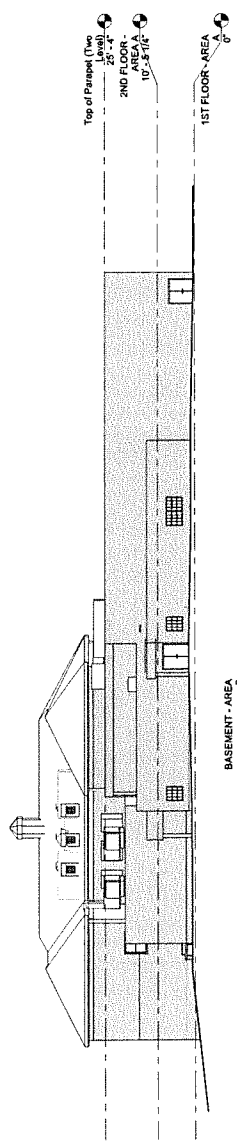
3

4

5



C5 EXISTING EAST ELEVATION
1/16" = 1'-0"



B5 EXISTING WEST ELEVATION
1/16" = 1'-0"


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2

3

4

5

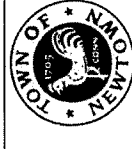

**HAWLEY
ELEMENTARY
SCHOOL**
24 CHURCH HILL ROAD
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ARCHITECT



CHRISTOPHER WILLIAMS ARCHITECTS, LLC
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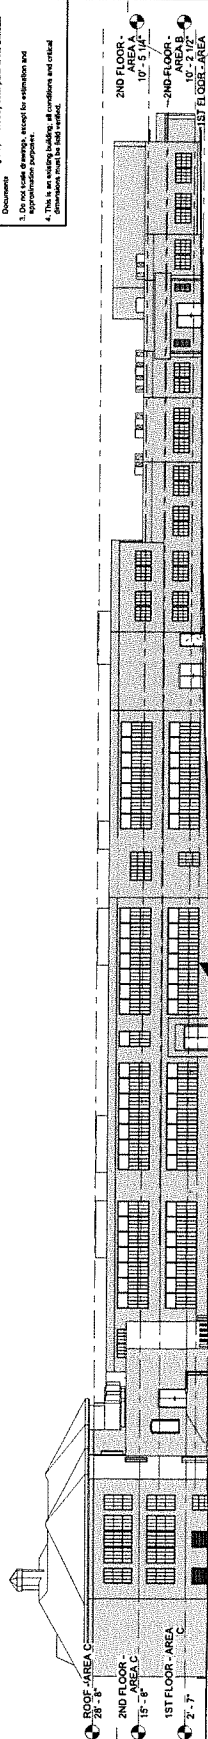
PROGRESS DRAWINGS
11/20/2020

EXTERIOR ELEVATIONS


AE201

GENERAL NOTES

1. The intent of the Contract Documents is to include all items necessary for the construction of the project. The Contractor shall be responsible for obtaining all necessary permits and approvals from the appropriate authorities. The Contractor shall provide the Architect with all necessary information and documentation to obtain the required permits and approvals. The Contractor shall be responsible for obtaining all necessary permits and approvals from the appropriate authorities. The Contractor shall provide the Architect with all necessary information and documentation to obtain the required permits and approvals.
2. REFERENCE KEY NOTES and SHEET KEY NOTES are provided for the Contractor's reference. The Contractor shall be responsible for obtaining all necessary permits and approvals from the appropriate authorities. The Contractor shall provide the Architect with all necessary information and documentation to obtain the required permits and approvals.
3. Do not make drawings, except for estimations and approximate purposes.
4. This drawing is for informational purposes only and is not to be used for construction or critical dimensions. It is not to be used for construction or critical dimensions.



(C5) EXISTING NORTH ELEVATION
1/16" = 1'-0"

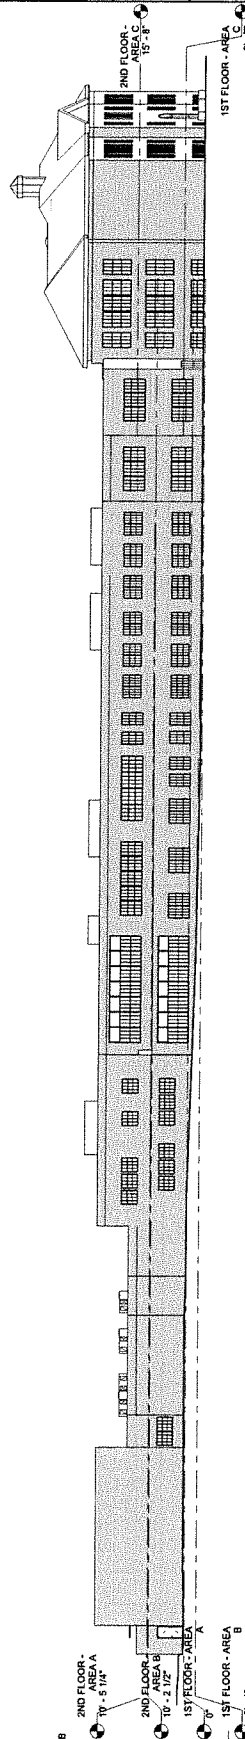

(A5) EXISTING SOUTH ELEVATION
1/16" = 1'-0"



**HAWLEY
ELEMENTARY
SCHOOL**
35 CHURCH HILL ROAD
NEW MILFORD, CT 06459

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CONSTRUCTION WORKMANSHIP ASSOCIATES
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200 New London Road South
Shorefield, CT 06082
Tel: (860) 286-8171
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EXTERIOR ELEVATIONS

AE202



**HAWLEY
ELEMENTARY
SCHOOL**
23 CHURCH HILL ROAD
NEWTOWN, CT 06470



CWA
CWA CONSULTING, LLC
1510 Main Street
Newtown, CT 06470
www.cwaconsulting.com




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Bloomfield, CT 06002
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PROGRESS DRAWINGS
11/20/2020

A5 SECTION - AREA A
1/4" = 1'-0"



1 2 3 4 5

KEY PLAN

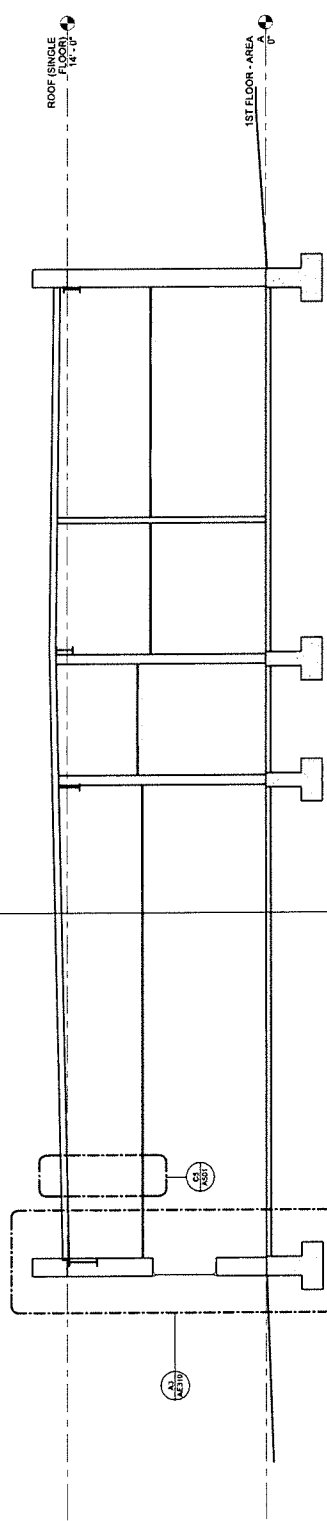

AE301

**BUILDING SECTIONS -
AREA A**

11/20/2020 1:18 PM



OWNER
**HAWLEY
ELEMENTARY
SCHOOL**
20 CHURCH HILL ROAD
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203.776.5184

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SUITE 100
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PROGRESS DRAWINGS

11/20/2020

DATE: 11/20/2020

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PROJECT NO: 2013

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DATE: 11/20/2020

PROJECT NO: 2013

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DATE: 11/20/2020

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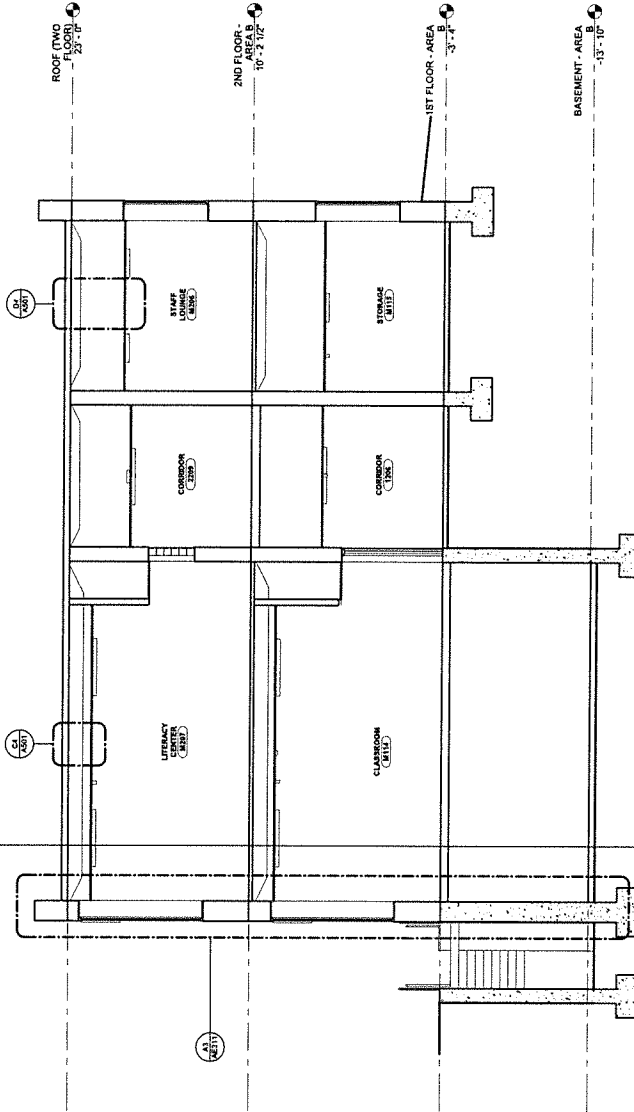
KEY PLAN




AREA B

AE302

A5 SECTION - AREA B
1/4" = 1'-0"



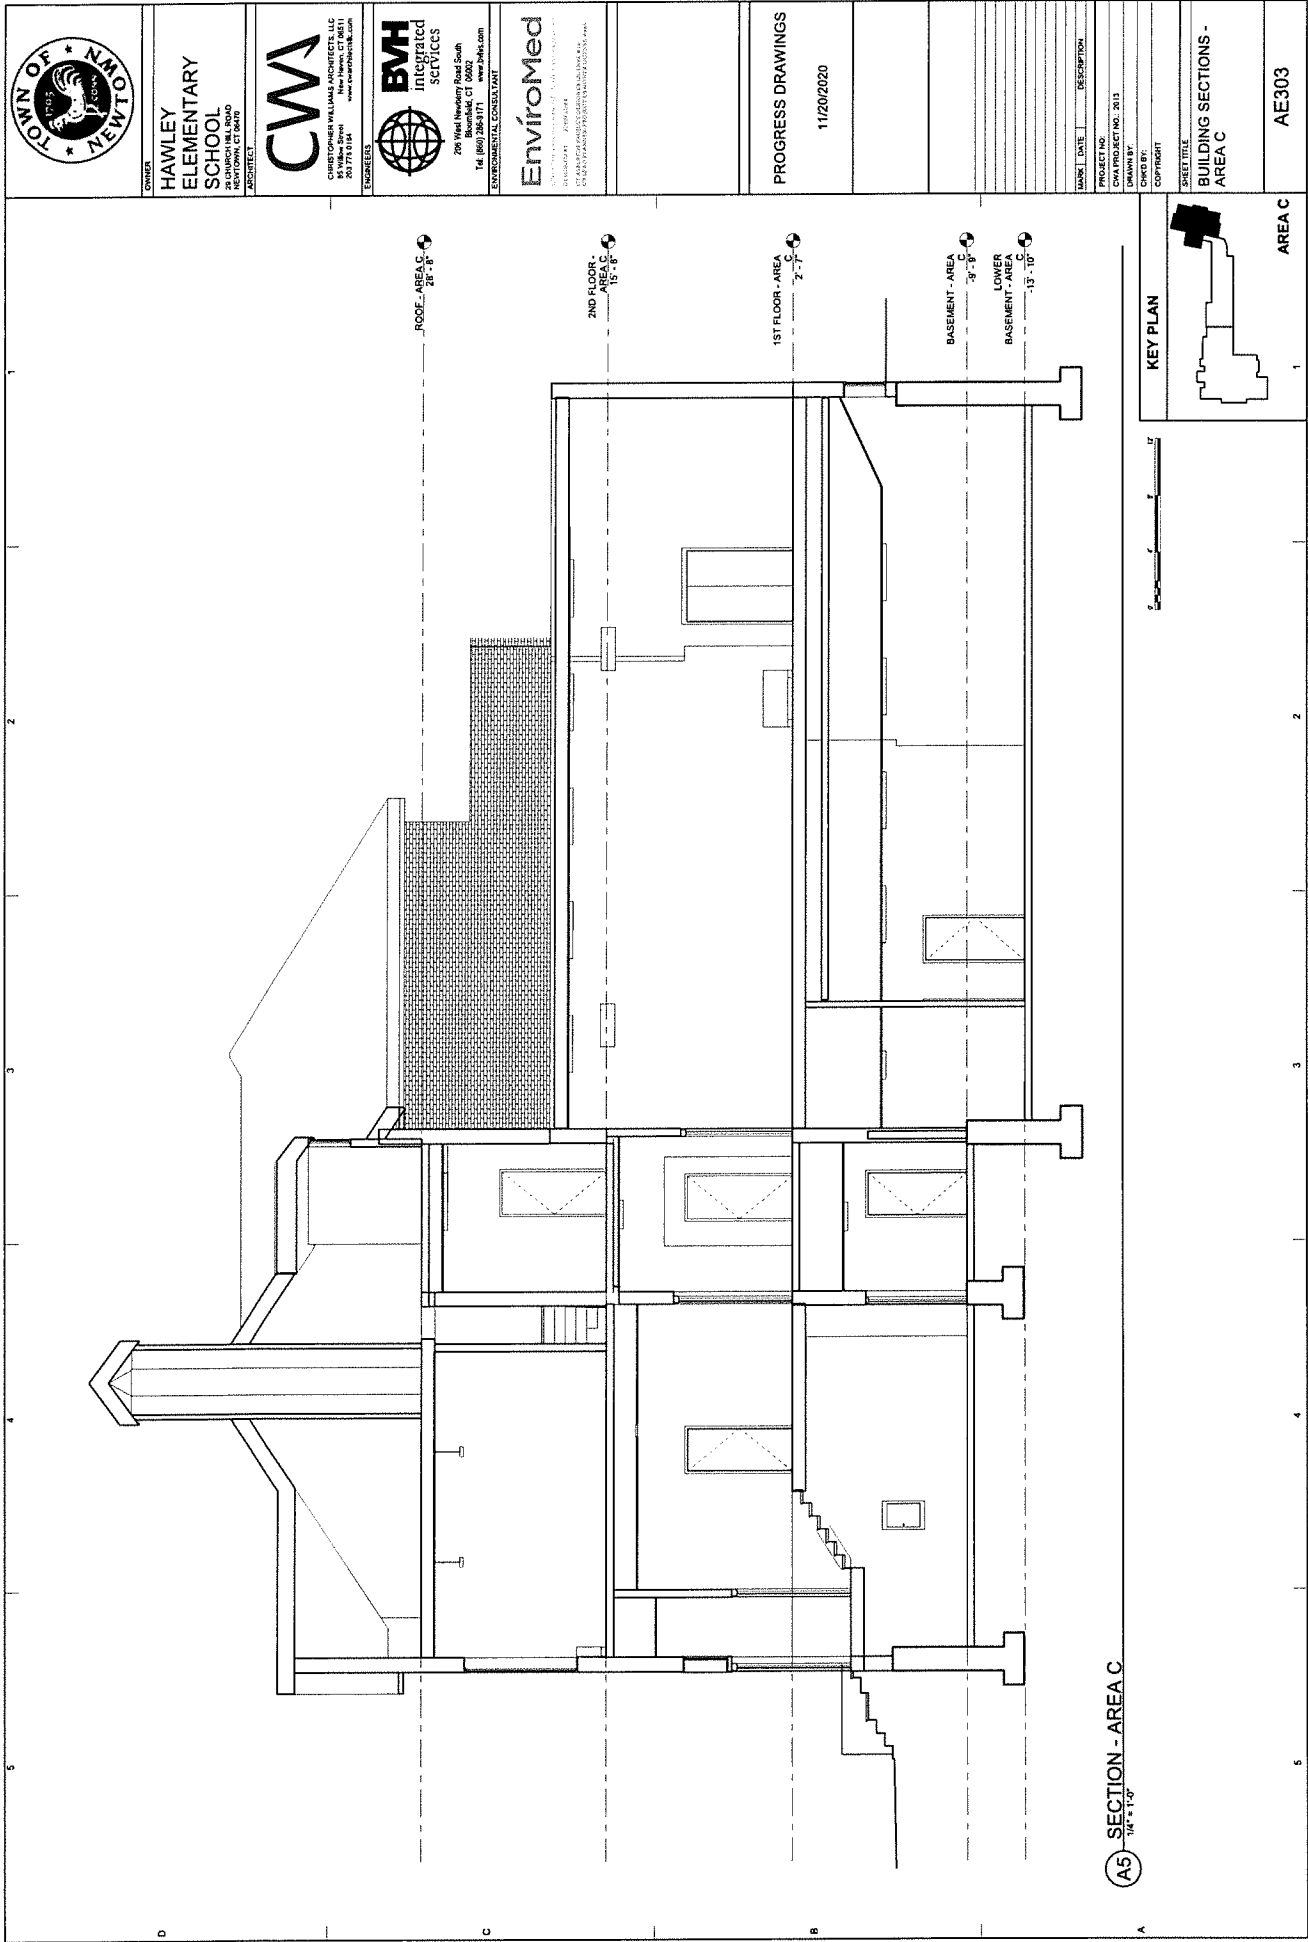



OWNER
**HAWLEY
ELEMENTARY
SCHOOL**
20 CHURCH HILL ROAD
NEWTON, CT 06470

ARCHITECT

CWA

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ENGINEERS



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ENVIRONMENTAL CONSULTANT

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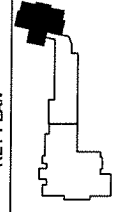
PROGRESS DRAWINGS

11/20/2020

a5 SECTION 2 - AREA C
1/4" = 1'-0"



KEY PLAN



AREA C

AE304

SHEET TITLE
**BUILDING SECTIONS -
AREA C**

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SCHOOL
300 WEST NEWBURY ROAD
NEWTON, CT 06459
ARCHITECT



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PROGRESS DRAWINGS

11/20/2020

MARKED DATE

DESCRIPTION

PROJECT NO.

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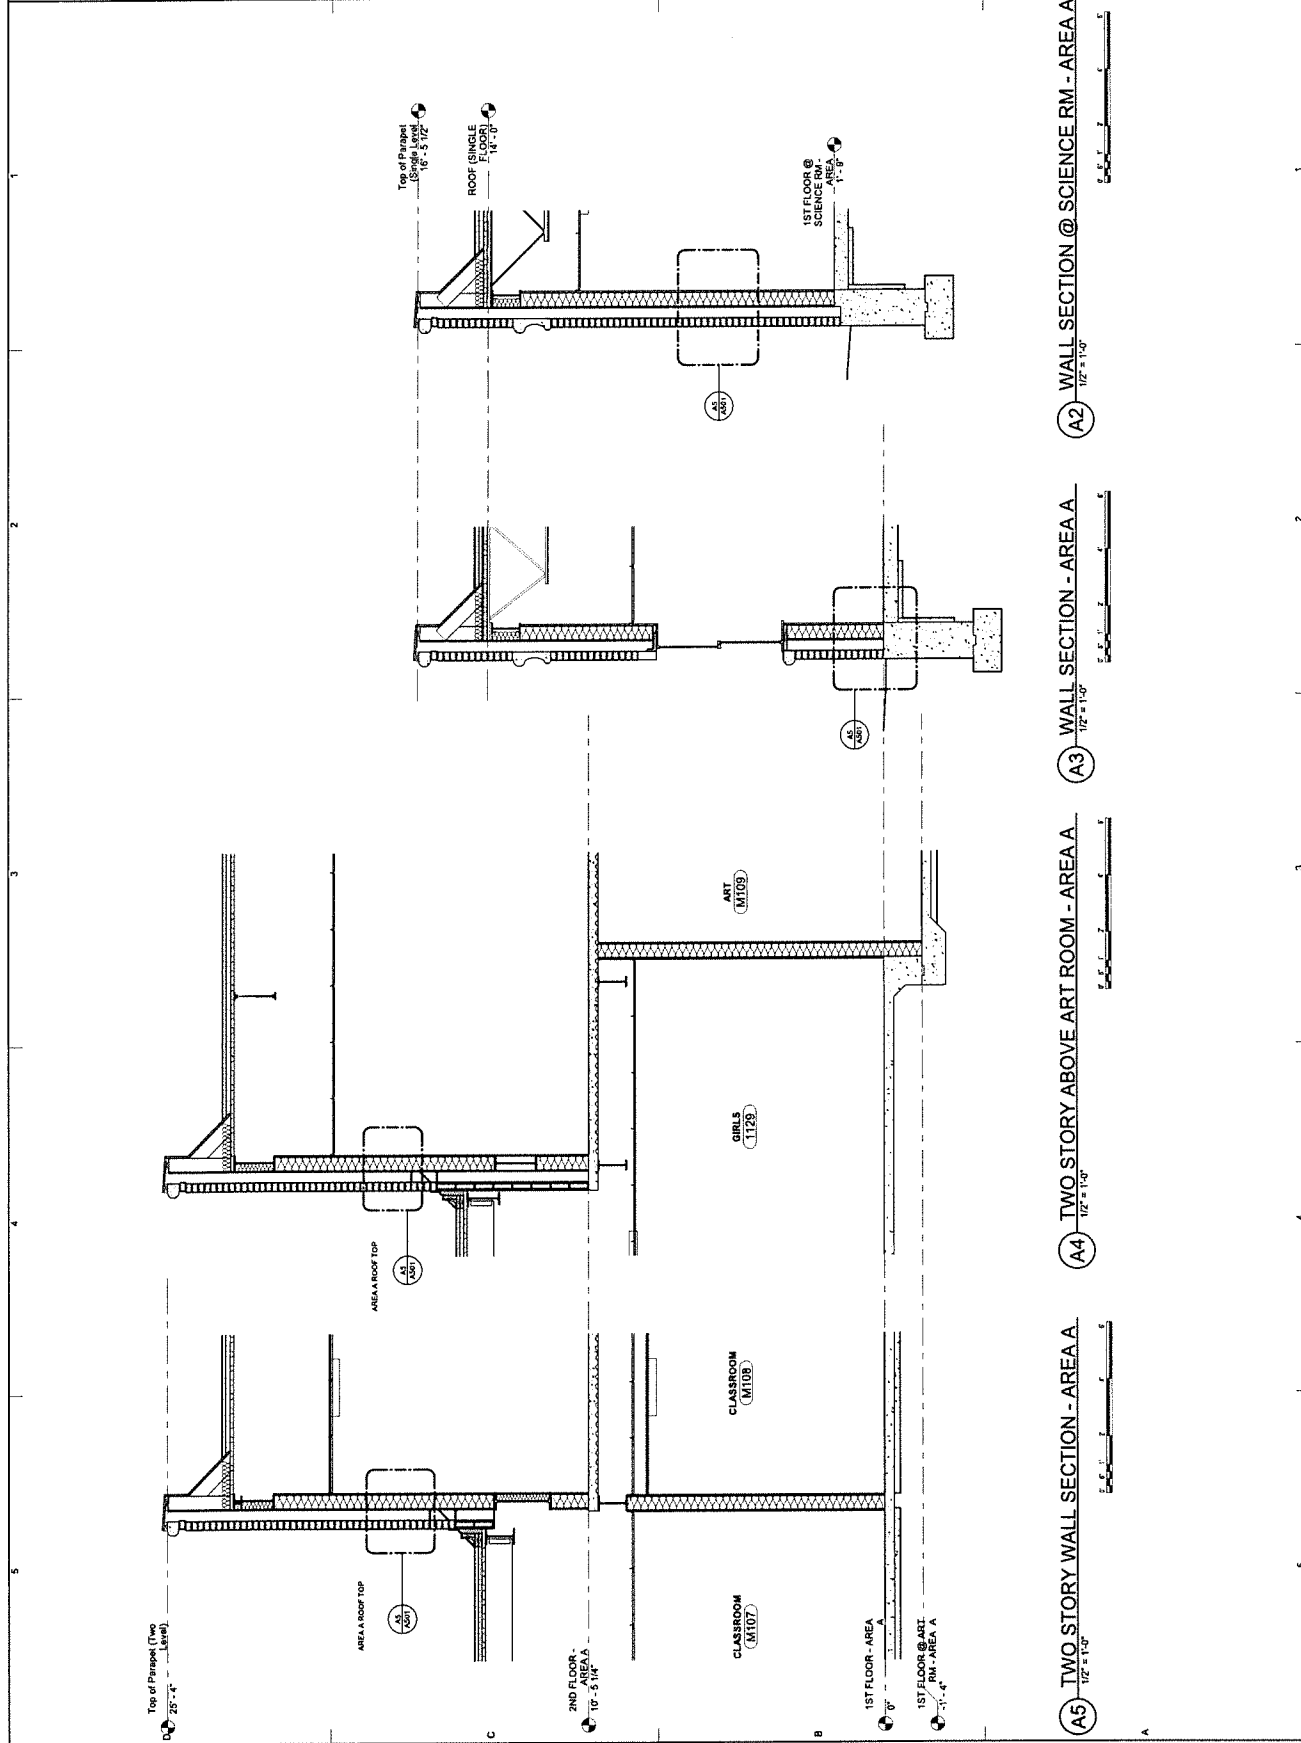
SHEET TITLE

WALL SECTIONS - AREA

A

AE310

11/20/2020 10:27 PM





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**HAWLEY
ELEMENTARY
SCHOOL**
100 West Newbury Road
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PROGRESS DRAWINGS


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MARKS | DATE | DESCRIPTION
PROJECT NO.
CWA PROJECT NO.: 3013
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SHEET TITLE
**WALL SECTIONS - AREA
C**


AE312

KEY PLAN



AREA C
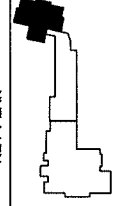
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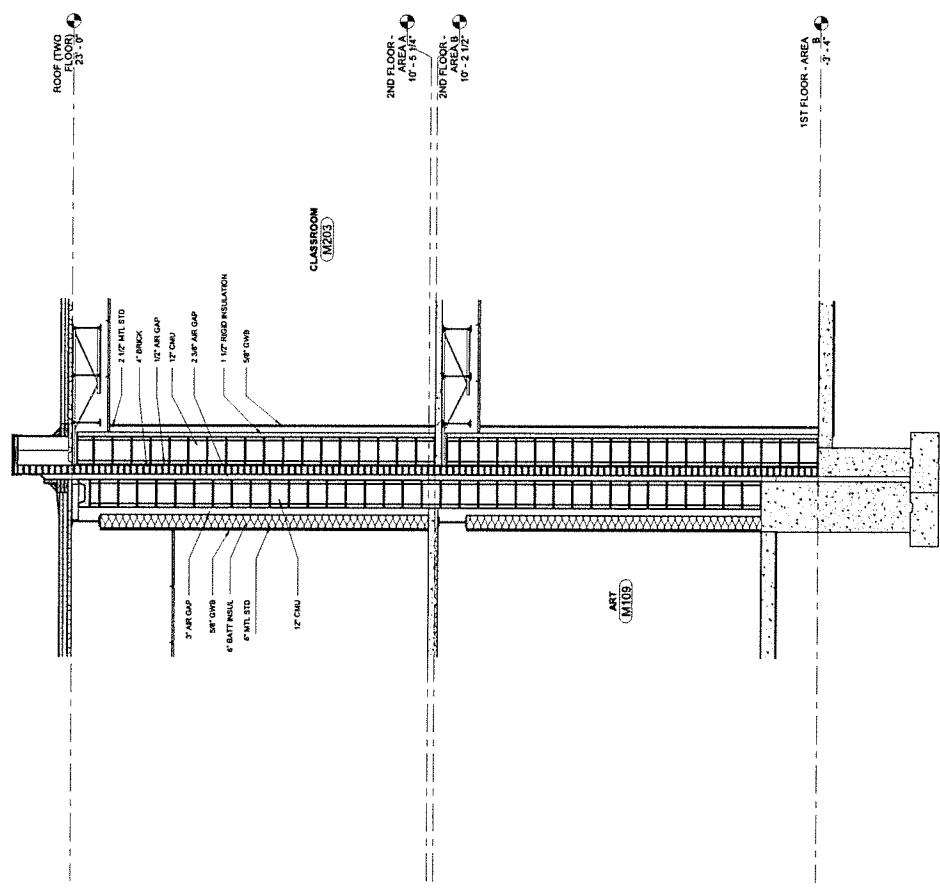
PROGRESS DRAWINGS
11/20/2020

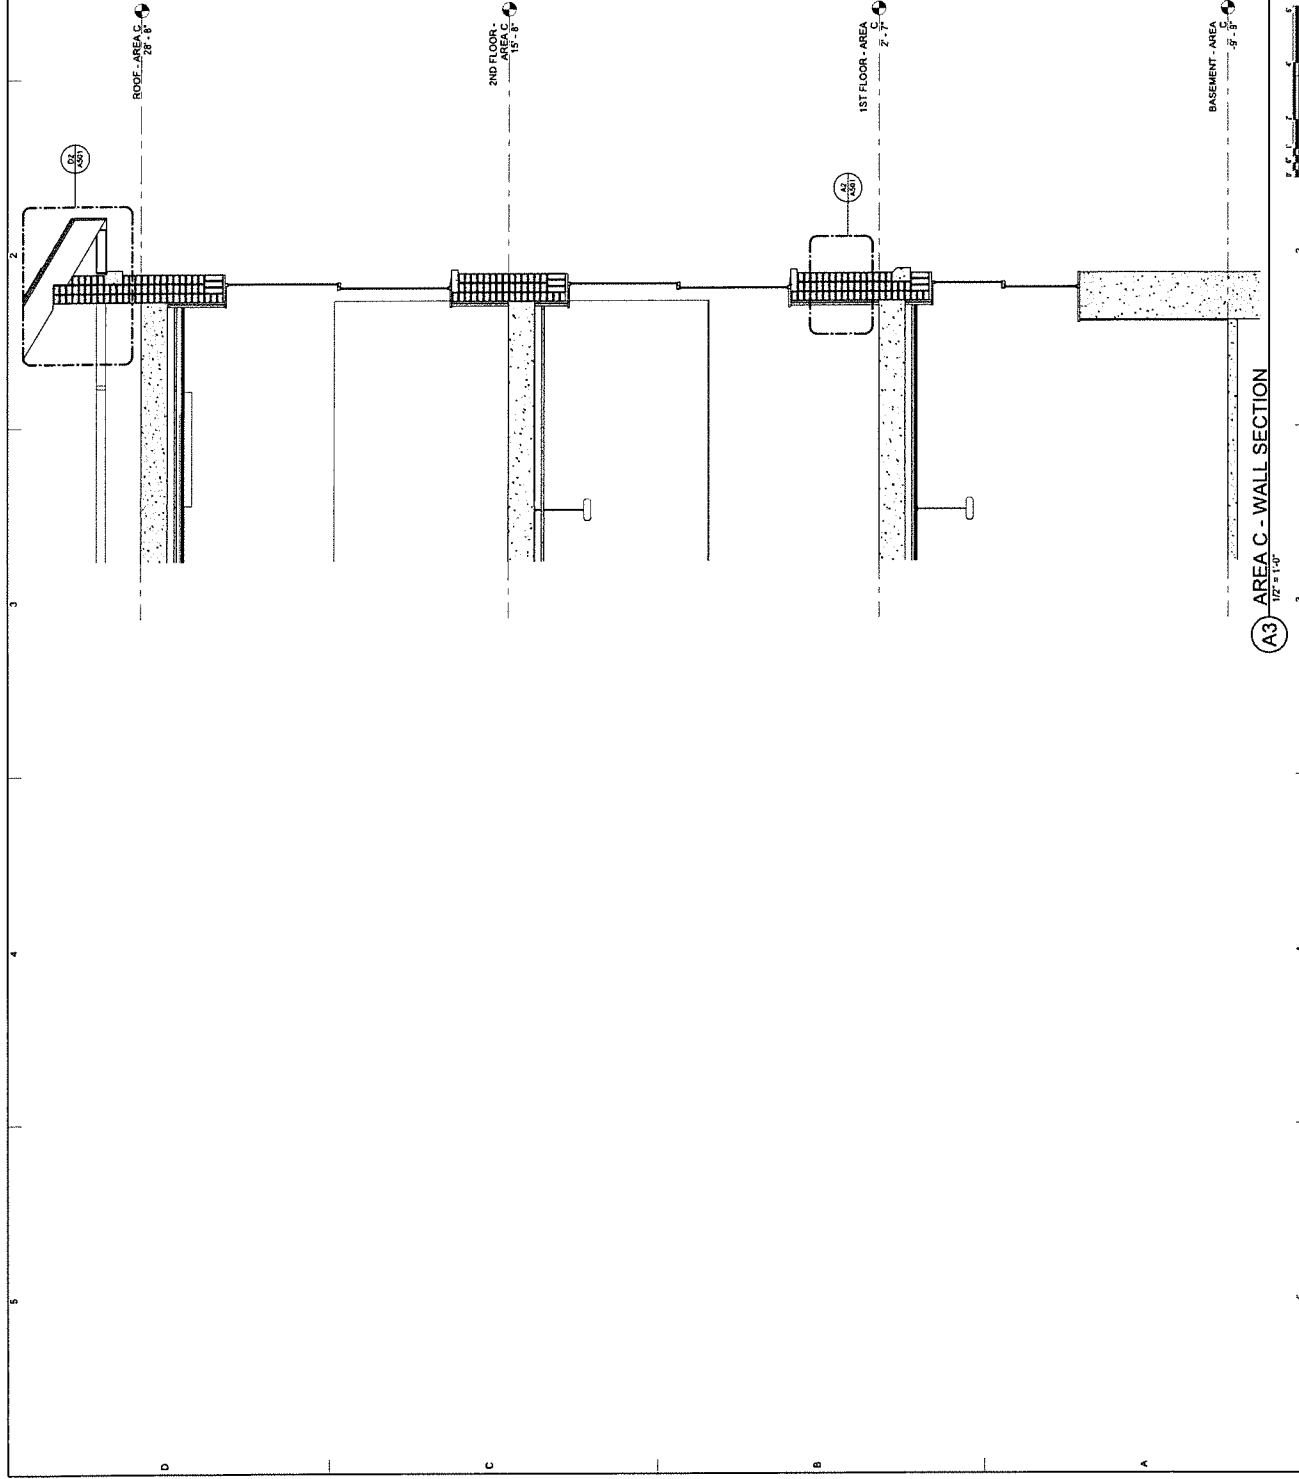NO.	DATE	DESCRIPTION
1	11/20/2020	PROJECT NO.
2		CWA PROJECT NO. 2013
3		DRAWN BY
4		CHECKED BY
5		DATE

**WALL SECTIONS - AREA
A/B JOINT**

AE313

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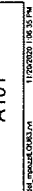
KEY PLAN

AREA A
1

AREA B
2

(A3) AREA A/B ADJOINING WALLS
1/2" = 1'-0"







**HAWLEY
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PROGRESS DRAWINGS


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CWA PROJECT NO.	2013	
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**OVERALL SECOND
FLOOR PLAN**

A102

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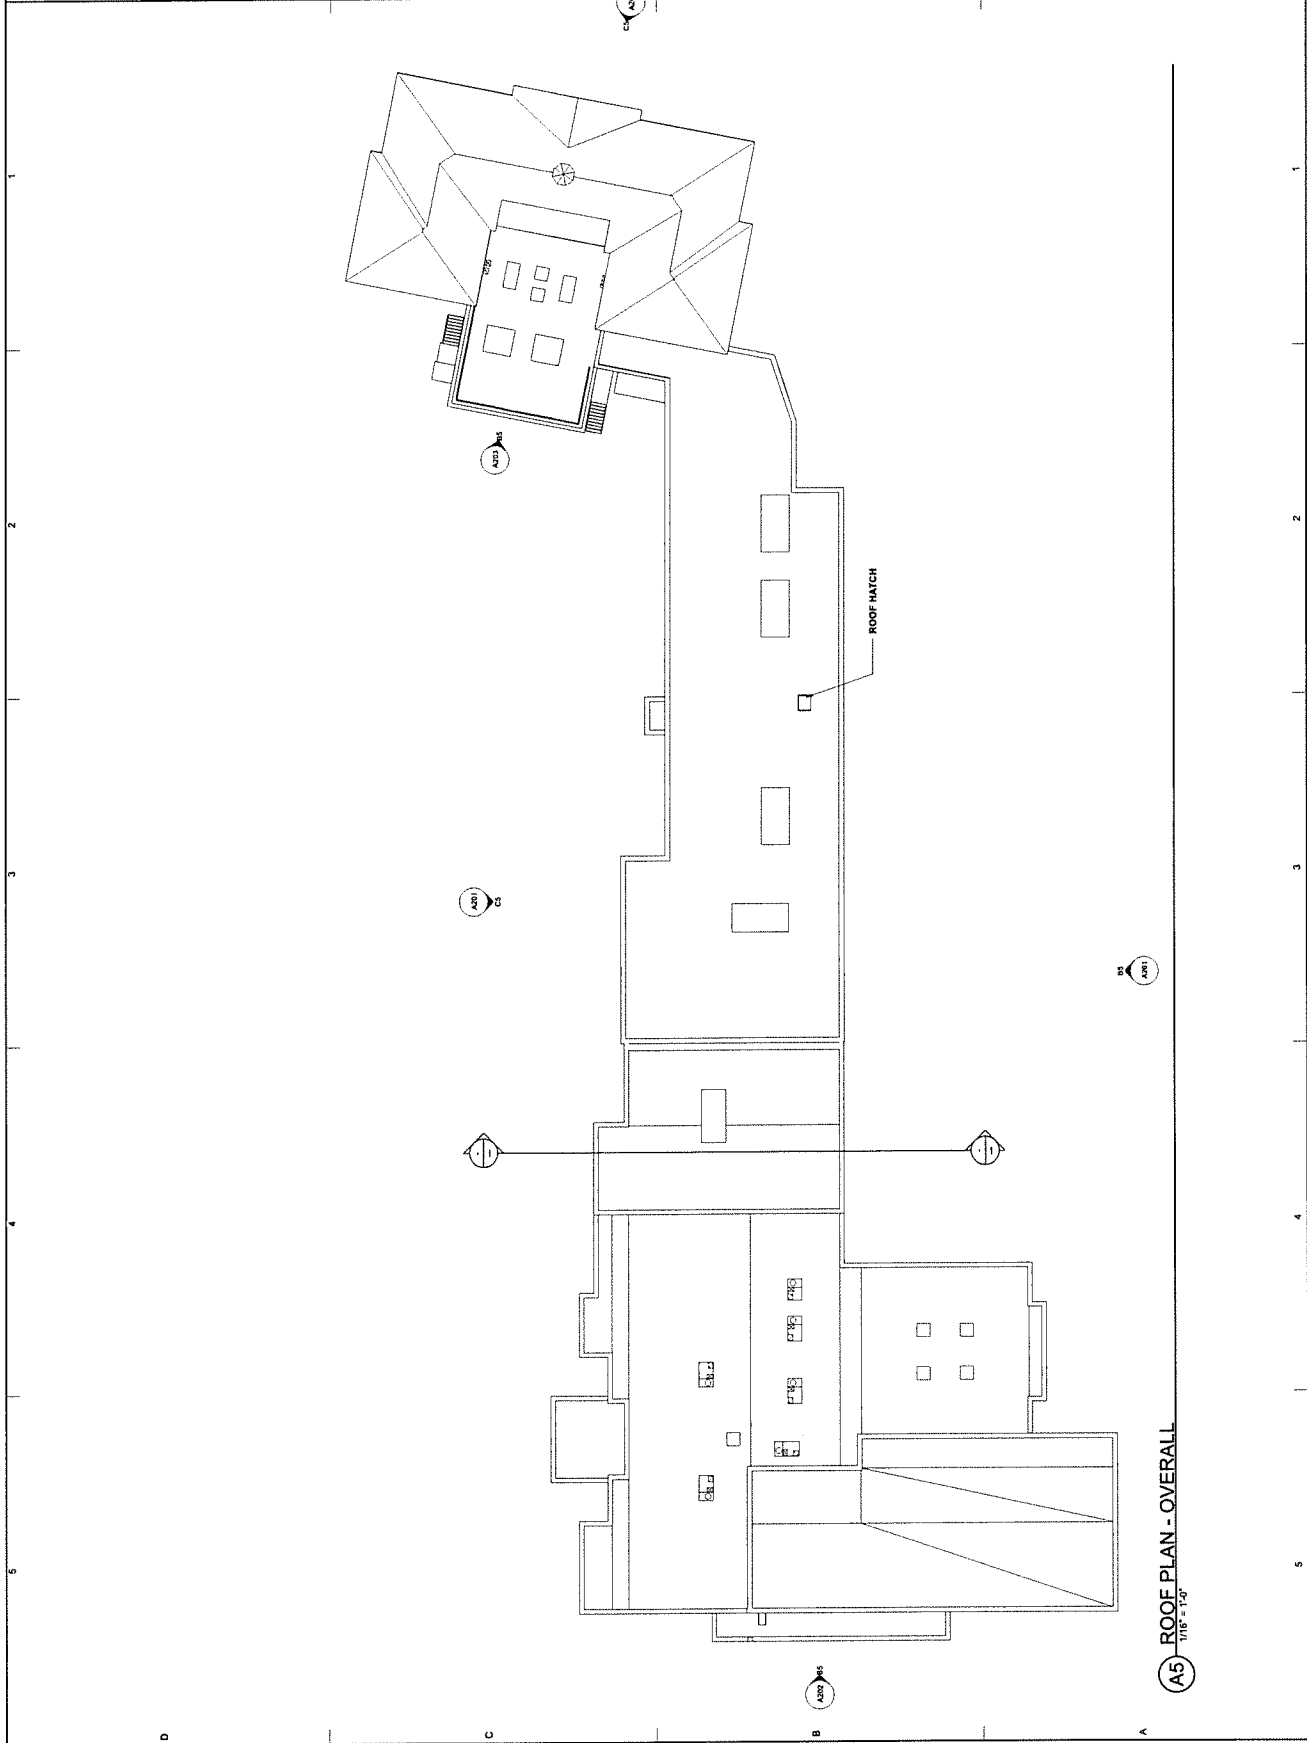
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PROGRESS DRAWINGS
11/20/2020

DATE	DESCRIPTION
11/20/2020	PROJECT NO.
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	DATE:

OVERALL ROOF PLAN

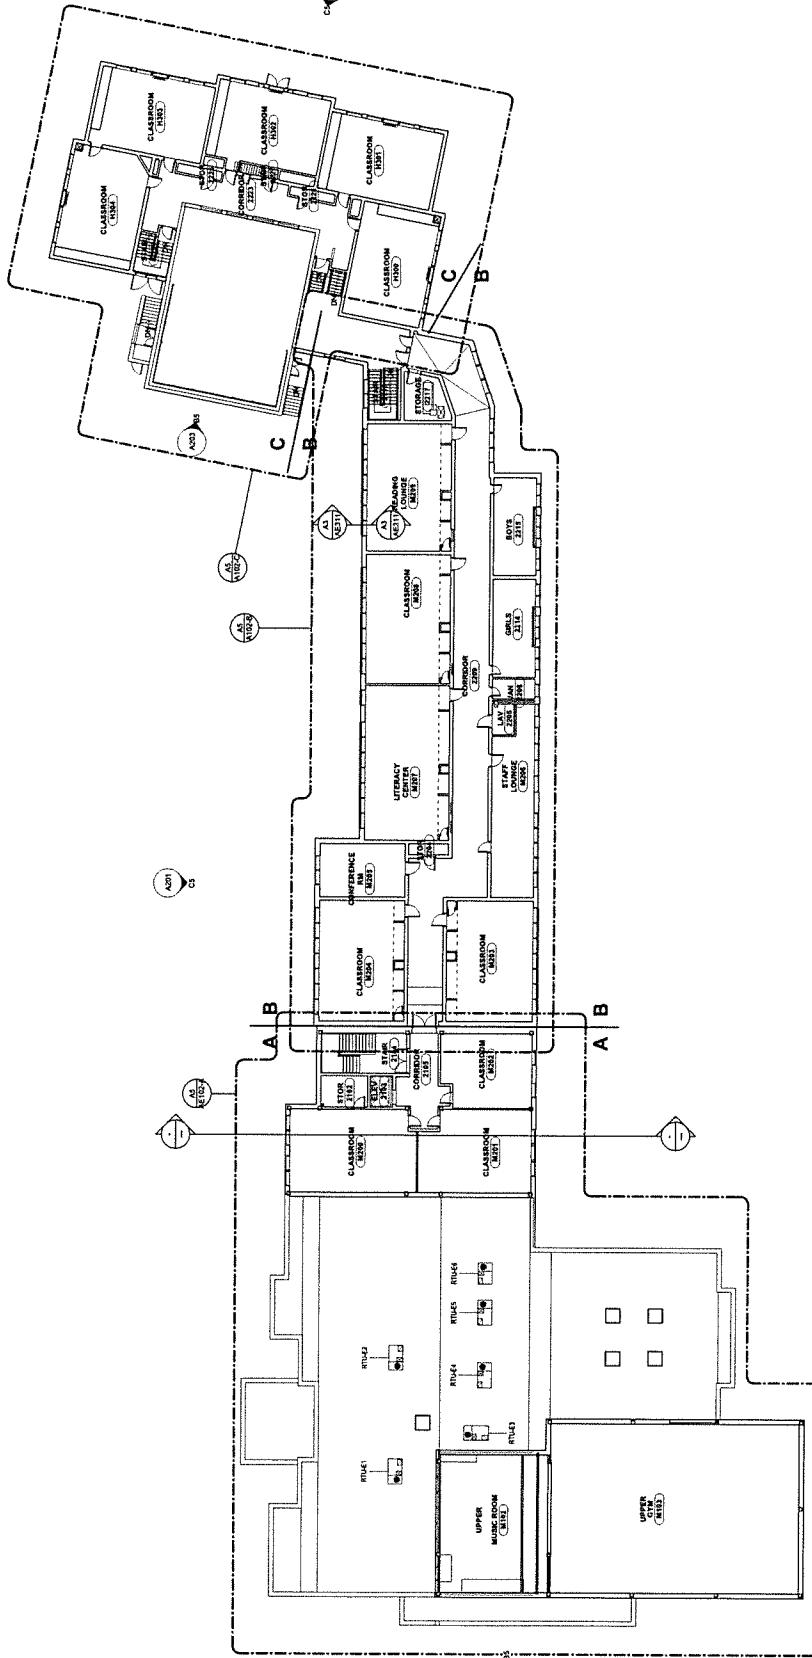A103



(A5) ROOF PLAN - OVERALL
1/16" = 1'-0"



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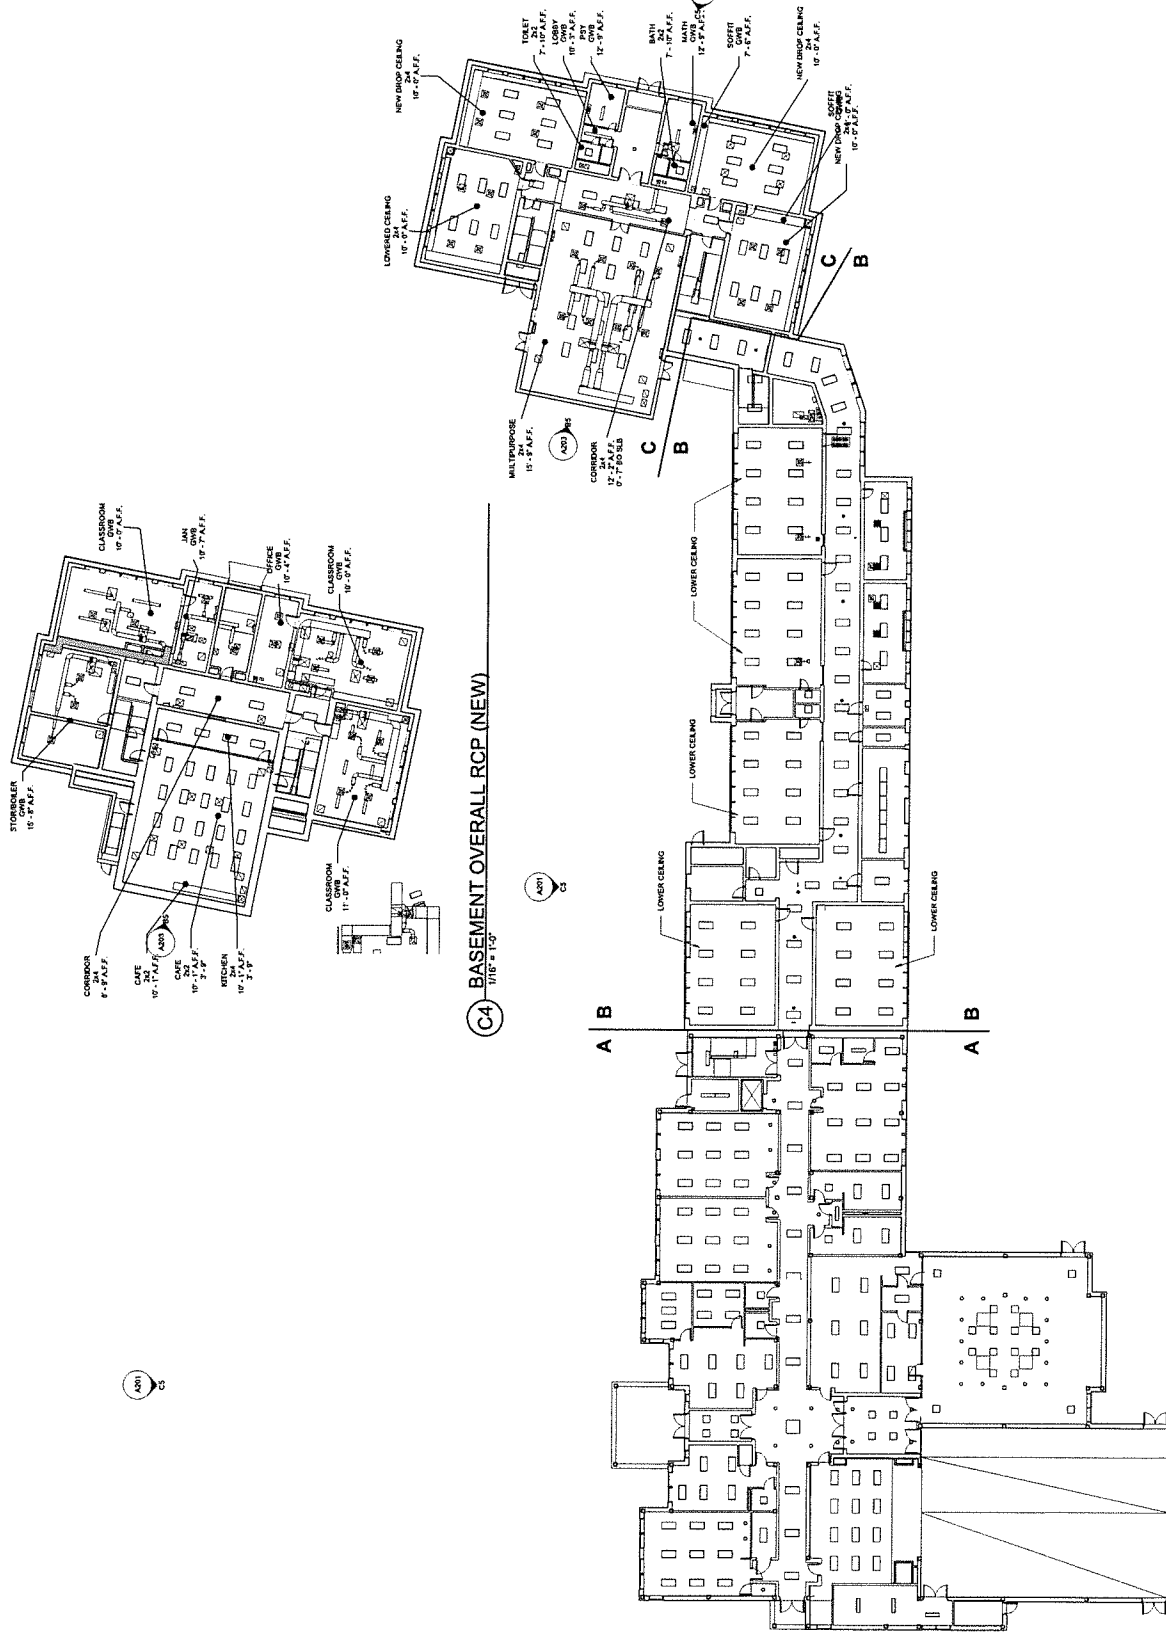
PROGRESS DRAWINGS
11/20/2020

NO.	DATE	DESCRIPTION
1	11/20/2020	ISSUED FOR PERMIT

SHEET TITLE
**OVERALL FIRST FLOOR
RCP**


A111

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A5
FIRST FLOOR RCP
1/16" = 1'-0"

C4
BASEMENT OVERALL RCP (NEW)
1/16" = 1'-0"



A5 2ND FLR OVERALL RCP
1/16" = 1'-0"

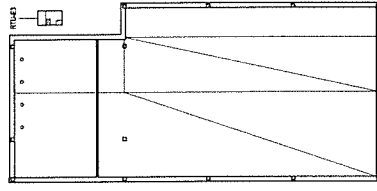

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PROGRESS DRAWINGS
11/20/2020

MARK	DATE	DESCRIPTION
PROJECT NO.		CWA PROJECT NO. 2013
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SHEET TITLE
BASEMENT PLAN AREA C


A100-C

GENERAL NOTES


1. The intent of the Contract Documents is to include all items necessary for the proper execution and completion of all Work. The Contractor shall be responsible for obtaining all necessary permits and approvals and shall be responsible for the proper execution and completion of all Work. The Contractor shall be responsible for the proper execution and completion of all Work. The Contractor shall be responsible for the proper execution and completion of all Work.
2. REFERENCE KEY NOTES and SHEET KEY NOTES are provided for the Contractor's reference. The Contractor shall be responsible for the proper execution and completion of all Work. The Contractor shall be responsible for the proper execution and completion of all Work. The Contractor shall be responsible for the proper execution and completion of all Work.
3. Do not make drawings, except for extensions and modifications, without the written approval of the Architect. All modifications must be made in accordance with the Contract Documents.

KEYNOTES


KEY PLAN

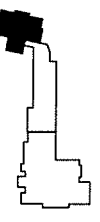

AREA C

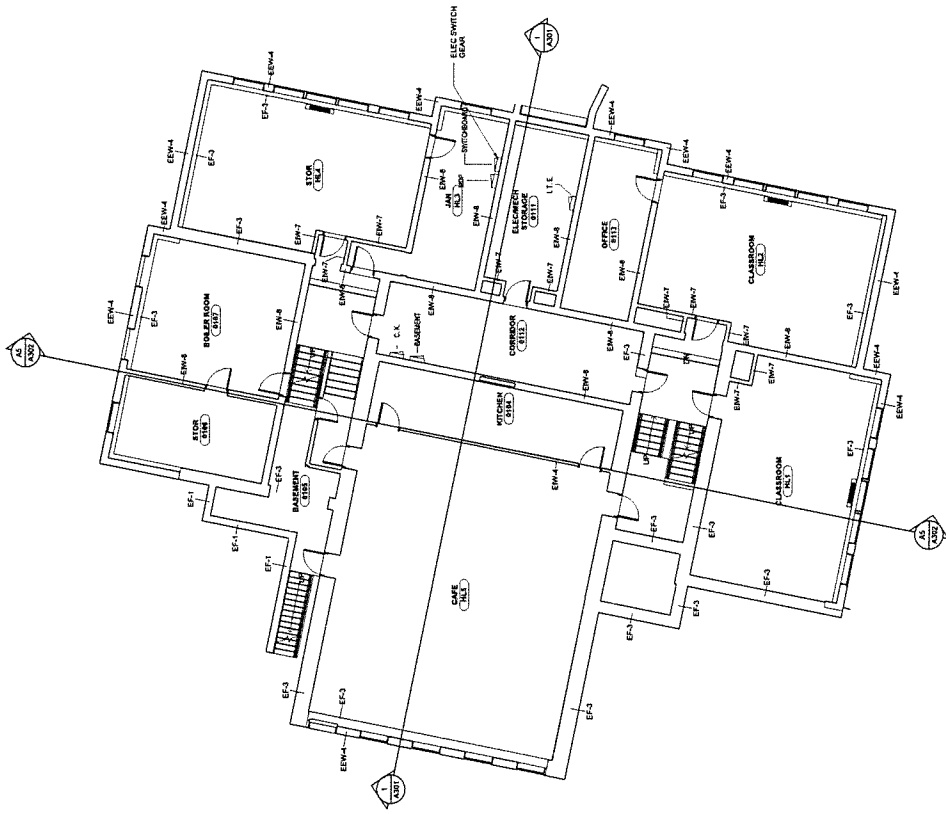

A5 BASEMENT FLOOR PLAN - AREA C
1/8" = 1'-0"

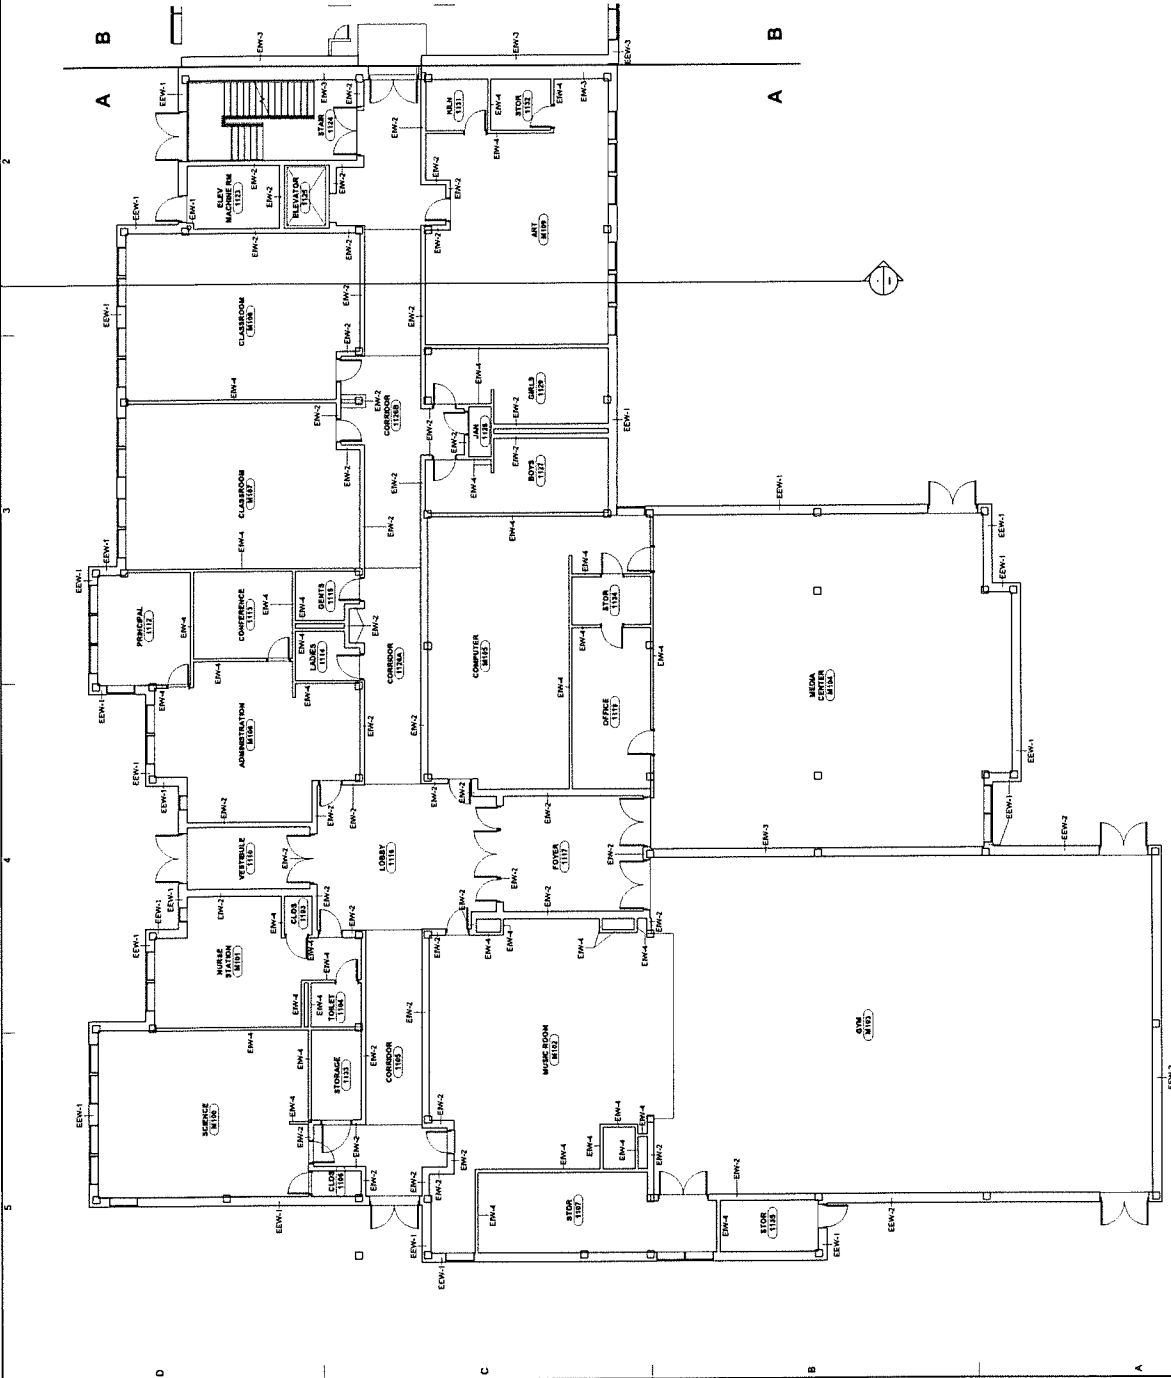


A5 EXISTING FIRST FLOOR PLAN - AREA A

GENERAL NOTES

1. The owner has provided a list of existing conditions and a list of proposed conditions. The architect has reviewed these and has determined that the proposed conditions are feasible and that the existing conditions are as shown on the drawings.
2. The architect has prepared these drawings in accordance with the requirements of the owner and the applicable building codes.
3. The architect has prepared these drawings in accordance with the requirements of the owner and the applicable building codes.
4. The architect has prepared these drawings in accordance with the requirements of the owner and the applicable building codes.

KEYNOTES

KEY PLAN

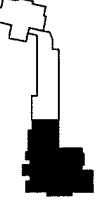

AREA A

SHEET TITLE

FIRST FLOOR PLAN

AREA A

A101-A



HAWLEY ELEMENTARY SCHOOL
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PROGRESS DRAWINGS
11/20/2020

MARK	DATE	DESCRIPTION
1	11/20/2020	PROGRESS DRAWING

PROJECT NO.
CWA PROJECT NO. 2013

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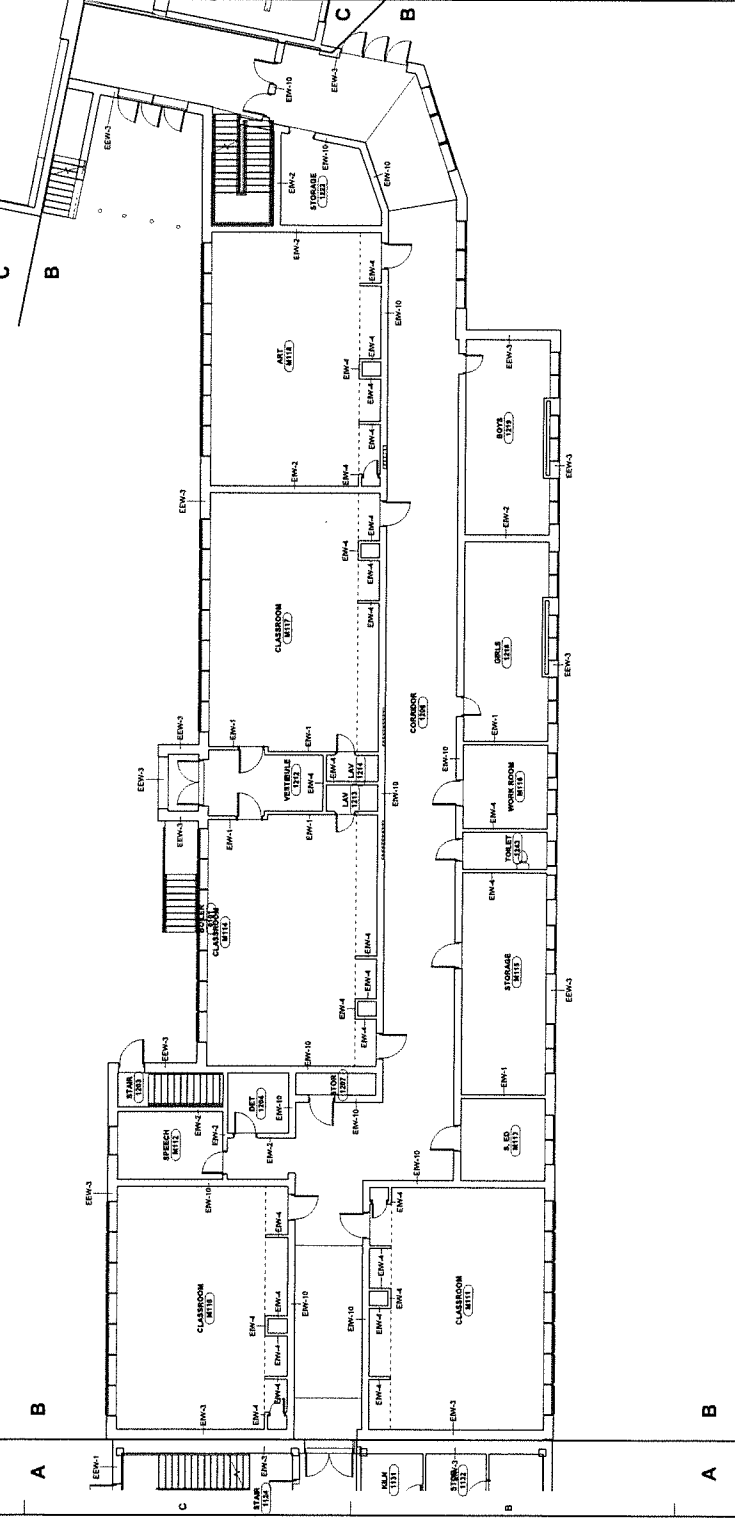
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GENERAL NOTES

1. The scope of the Contract Documents is to include all items necessary for the proper installation and completion of all work shown on the drawings and specified in the Schedule of Values. The Contractor shall be responsible for obtaining all necessary permits, licenses, and approvals from the appropriate authorities. The Contractor shall provide the Architect with a copy of all permits, licenses, and approvals obtained. The Contractor shall be responsible for the safety of all workers and the public. The Contractor shall be responsible for the protection of all existing structures and utilities. The Contractor shall be responsible for the removal and disposal of all debris and waste. The Contractor shall be responsible for the maintenance of all accessways and easements. The Contractor shall be responsible for the completion of all work in accordance with the Contract Documents. The Contractor shall be responsible for the payment of all bills of materials and subcontractors. The Contractor shall be responsible for the payment of all taxes and fees. The Contractor shall be responsible for the payment of all insurance premiums. The Contractor shall be responsible for the payment of all other costs and expenses. The Contractor shall be responsible for the completion of all work in accordance with the Contract Documents. The Contractor shall be responsible for the payment of all bills of materials and subcontractors. The Contractor shall be responsible for the payment of all taxes and fees. The Contractor shall be responsible for the payment of all insurance premiums. The Contractor shall be responsible for the payment of all other costs and expenses.
2. REFERENCE KEY NOTES AND SHEET KEY NOTES are provided to indicate and clarify the scope and requirements of the work shown on the drawings. The Contractor shall be responsible for reading and understanding all key notes. The Contractor shall be responsible for the completion of all work in accordance with the Contract Documents. The Contractor shall be responsible for the payment of all bills of materials and subcontractors. The Contractor shall be responsible for the payment of all taxes and fees. The Contractor shall be responsible for the payment of all insurance premiums. The Contractor shall be responsible for the payment of all other costs and expenses.
3. Do not scale drawings, except for estimation and approximation purposes.
4. Dimensions shown on drawings are approximate and shall be used as a guide only. The Contractor shall be responsible for the completion of all work in accordance with the Contract Documents. The Contractor shall be responsible for the payment of all bills of materials and subcontractors. The Contractor shall be responsible for the payment of all taxes and fees. The Contractor shall be responsible for the payment of all insurance premiums. The Contractor shall be responsible for the payment of all other costs and expenses.


KEYNOTES

1. Keynotes are used to indicate and clarify the scope and requirements of the work shown on the drawings.
2. Keynotes are used to indicate and clarify the scope and requirements of the work shown on the drawings.
3. Keynotes are used to indicate and clarify the scope and requirements of the work shown on the drawings.
4. Keynotes are used to indicate and clarify the scope and requirements of the work shown on the drawings.



EXISTING FIRST FLOOR PLAN - AREA B
100-110


KEY PLAN

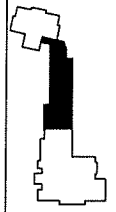

AREA B
1

FIRST FLOOR PLAN
AREA B

A101-B

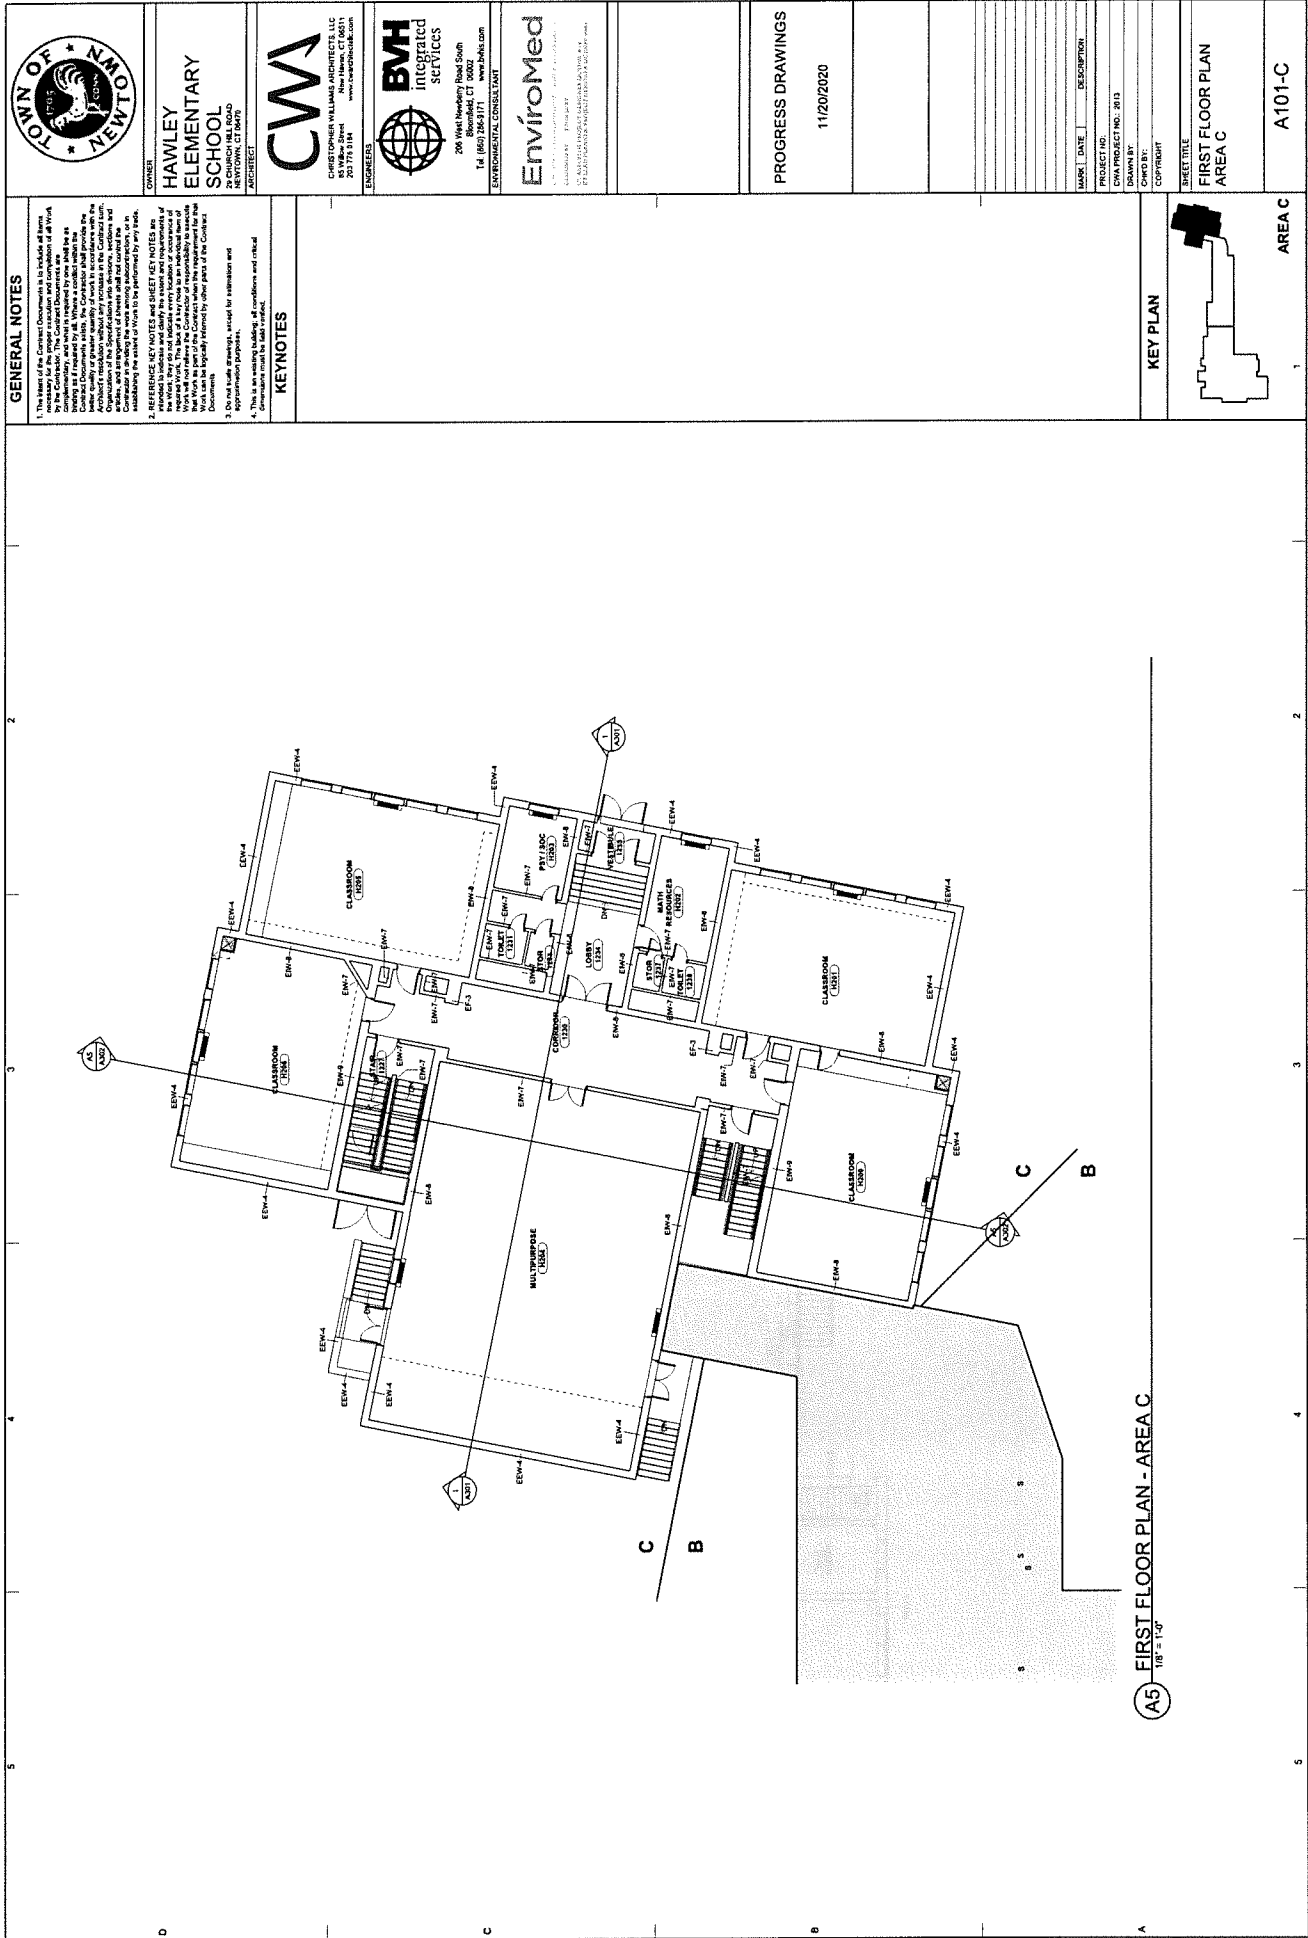


GENERAL NOTES

1. This floor plan is a conceptual drawing and is not intended to be used for construction. It is intended to provide a general overview of the proposed design and to illustrate the general arrangement of the building. The final design and construction shall be determined by the architect and the owner.
2. The building shall be constructed in accordance with the applicable building codes and standards. The building shall be designed to provide a safe and secure environment for the students and staff.
3. The building shall be designed to provide a functional and efficient learning environment. The building shall be designed to provide a variety of learning spaces and activities.
4. The building shall be designed to provide a high-quality educational experience. The building shall be designed to provide a variety of learning spaces and activities.

KEYNOTES

1. This is an existing building. All conditions and critical dimensions shall be maintained.

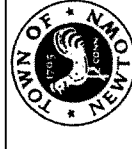

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PROGRESS DRAWINGS

11/20/2020

NO.	DATE	DESCRIPTION
1	11/20/2020	1st Floor Plan - Area C

KEY PLAN
FIRST FLOOR PLAN
AREA C

A101-C



**HAWLEY
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PROGRESS DRAWINGS
11/20/2020

NO.	DATE	DESCRIPTION
1	11/20/2020	ISSUED FOR PERMIT

PROJECT NO.	CWA PROJECT NO. 2013
OWNER BY	NEW MILFORD TOWN
DESIGNED BY	CWA
CONSULTANT	ENVIRONMENTAL CONSULTANTS


SHEET TITLE	SECOND FLOOR PLAN AREA A
SHEET NO.	A102-A

GENERAL NOTES

1. The intent of the Contract Documents is to include all items necessary for the construction of the project. The Contractor shall be responsible for obtaining all necessary permits and approvals from the appropriate authorities. The Contractor shall be responsible for obtaining all necessary permits and approvals from the appropriate authorities. The Contractor shall be responsible for obtaining all necessary permits and approvals from the appropriate authorities.
2. REFERENCE ANY NOTES AND SHEET KEY NOTES are provided for the Contractor's information. The Contractor shall be responsible for obtaining all necessary permits and approvals from the appropriate authorities. The Contractor shall be responsible for obtaining all necessary permits and approvals from the appropriate authorities. The Contractor shall be responsible for obtaining all necessary permits and approvals from the appropriate authorities.
3. Do not make drawings, except for the establishment and location of the project. The Contractor shall be responsible for obtaining all necessary permits and approvals from the appropriate authorities. The Contractor shall be responsible for obtaining all necessary permits and approvals from the appropriate authorities. The Contractor shall be responsible for obtaining all necessary permits and approvals from the appropriate authorities.
4. This is a preliminary drawing. All conditions are subject to change without notice. The Contractor shall be responsible for obtaining all necessary permits and approvals from the appropriate authorities. The Contractor shall be responsible for obtaining all necessary permits and approvals from the appropriate authorities. The Contractor shall be responsible for obtaining all necessary permits and approvals from the appropriate authorities.


KEYNOTES

KEY PLAN

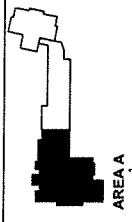


AREA A


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

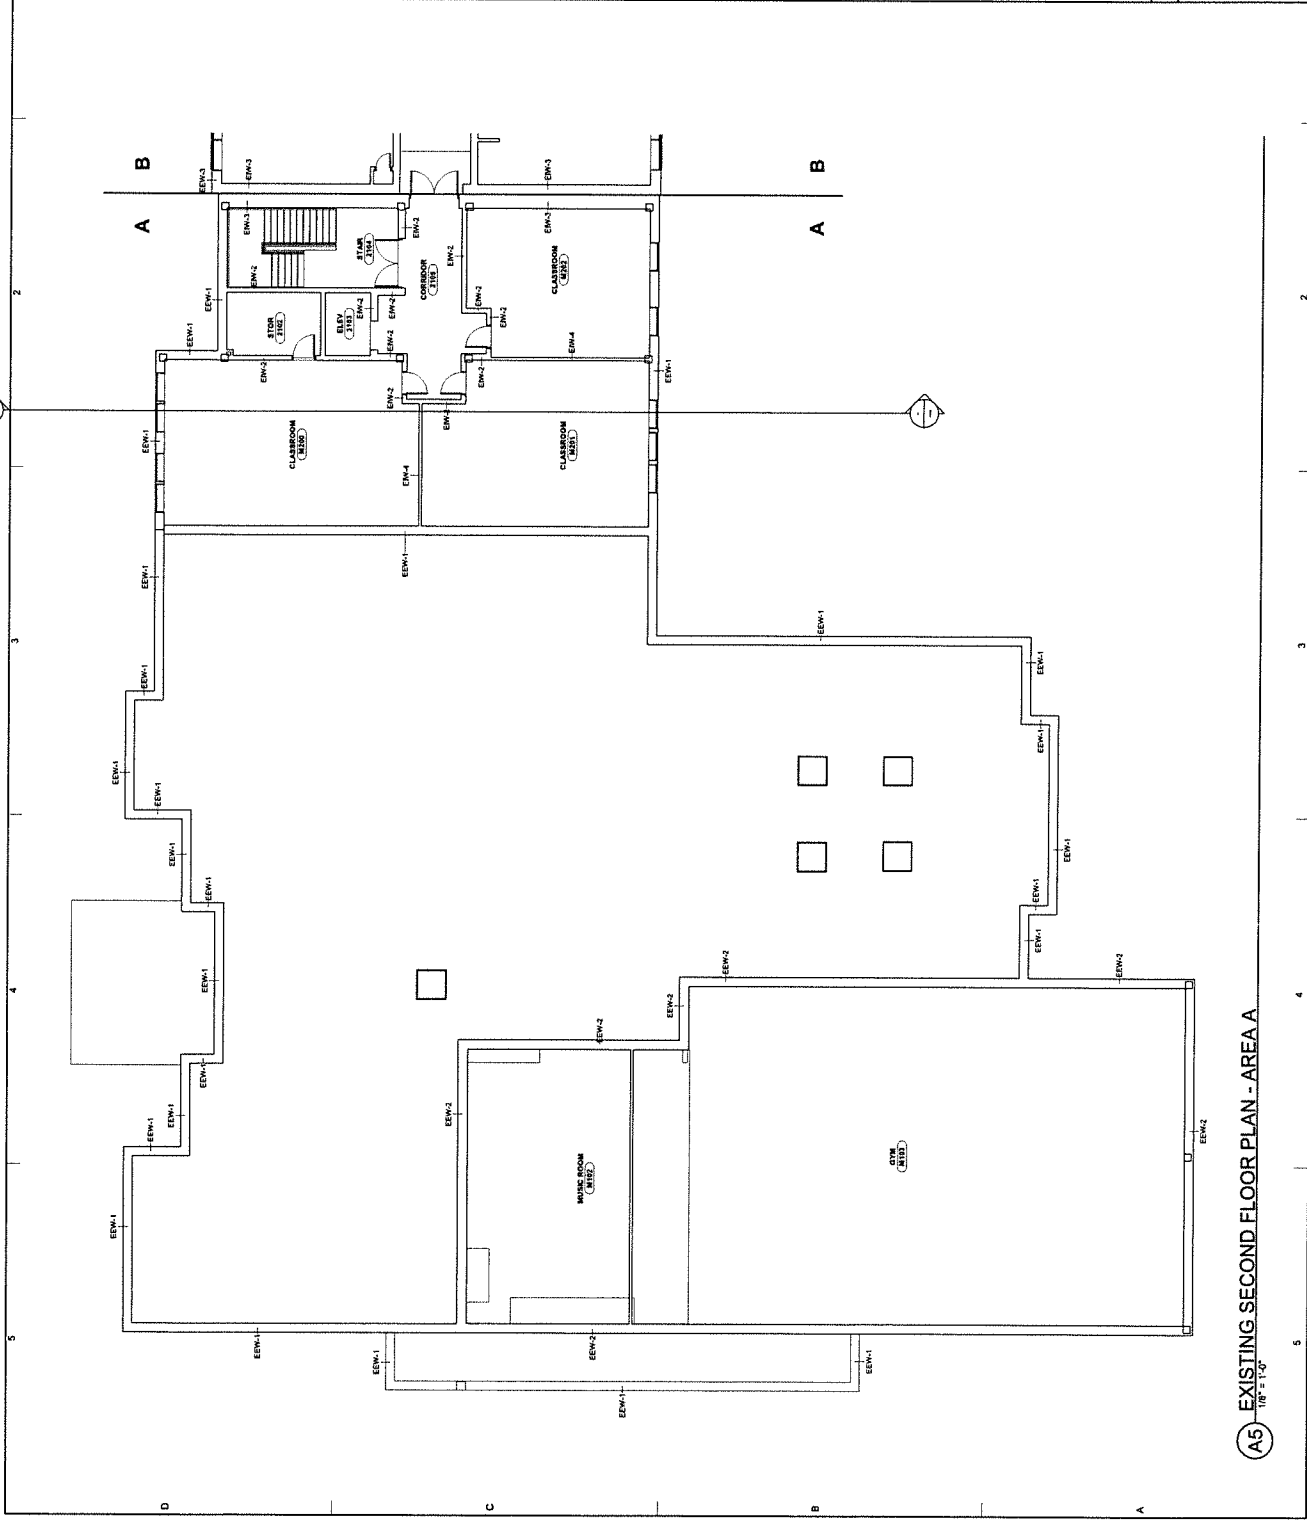
A5 EXISTING SECOND FLOOR PLAN - AREA A
1/8" = 1'-0"

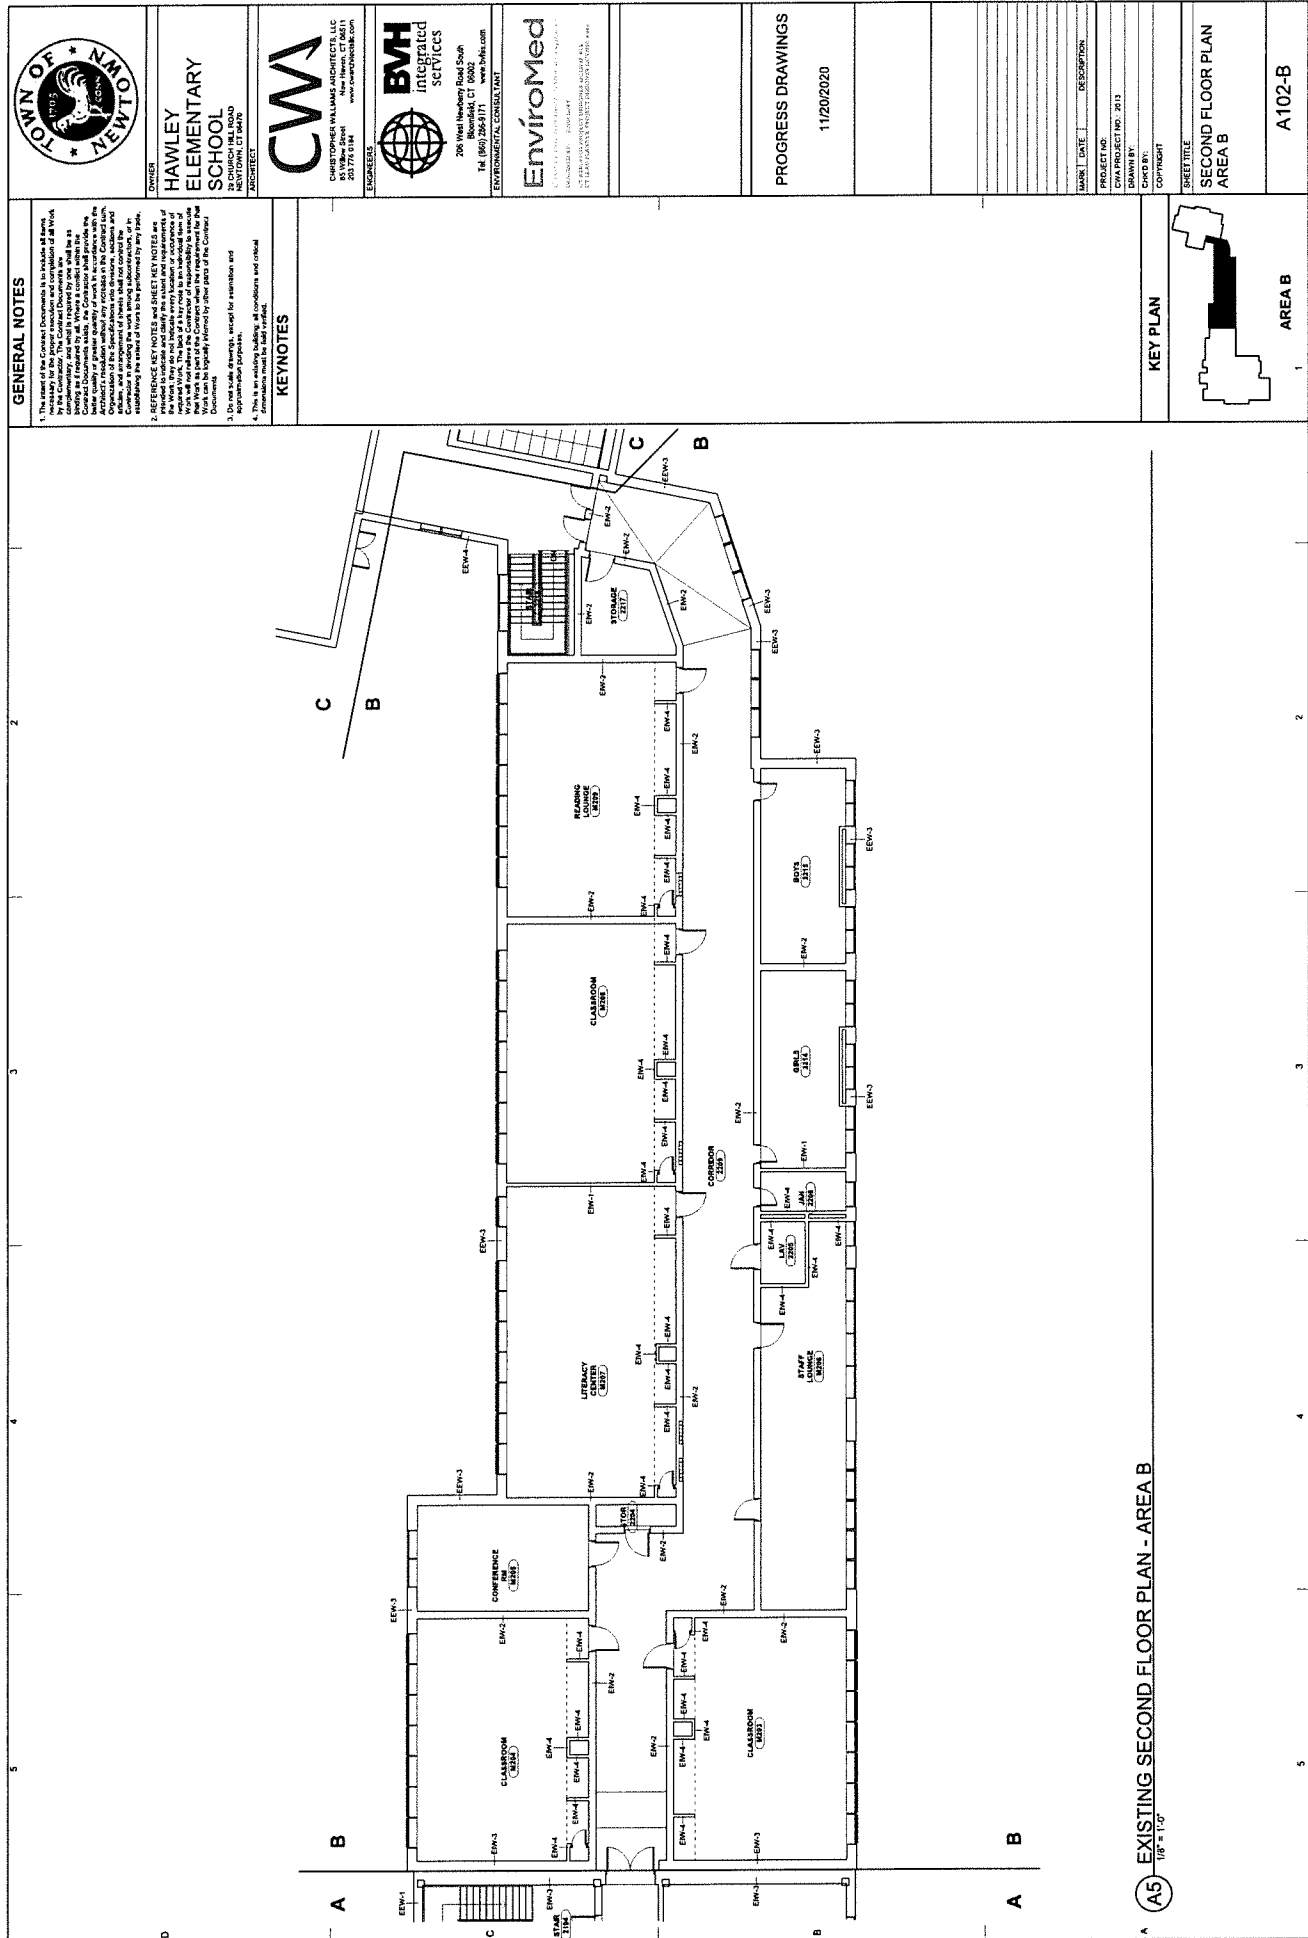

A5 EXISTING SECOND FLOOR PLAN - AREA B
1/8" = 1'-0"



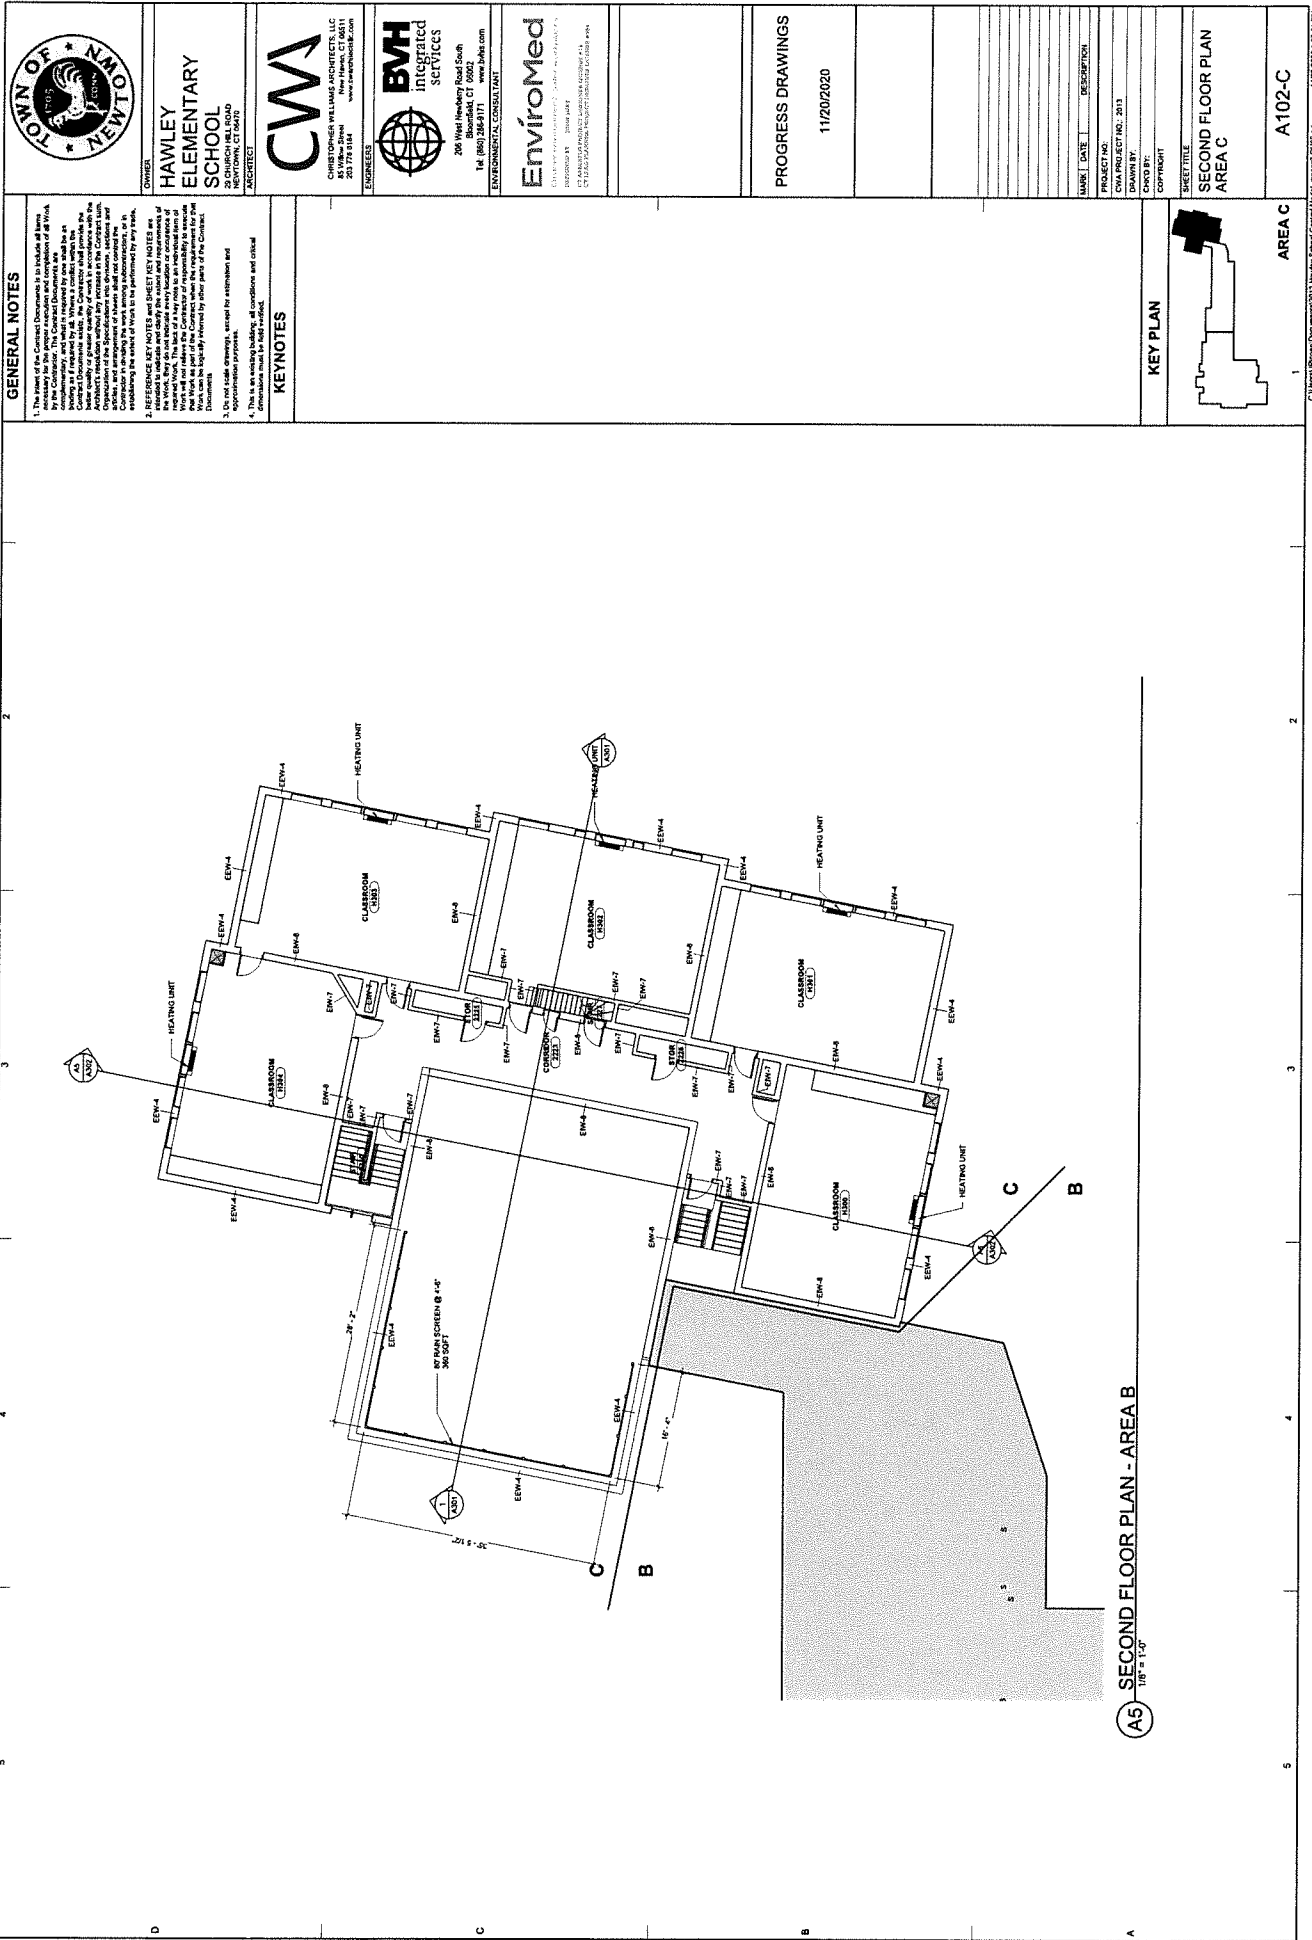

TOWN OF NEW MILFORD

HAWLEY ELEMENTARY SCHOOL

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PROGRESS DRAWINGS

11/20/2020

DATE	DESCRIPTION
11/20/2020	11/20/2020

PROJECT NO.

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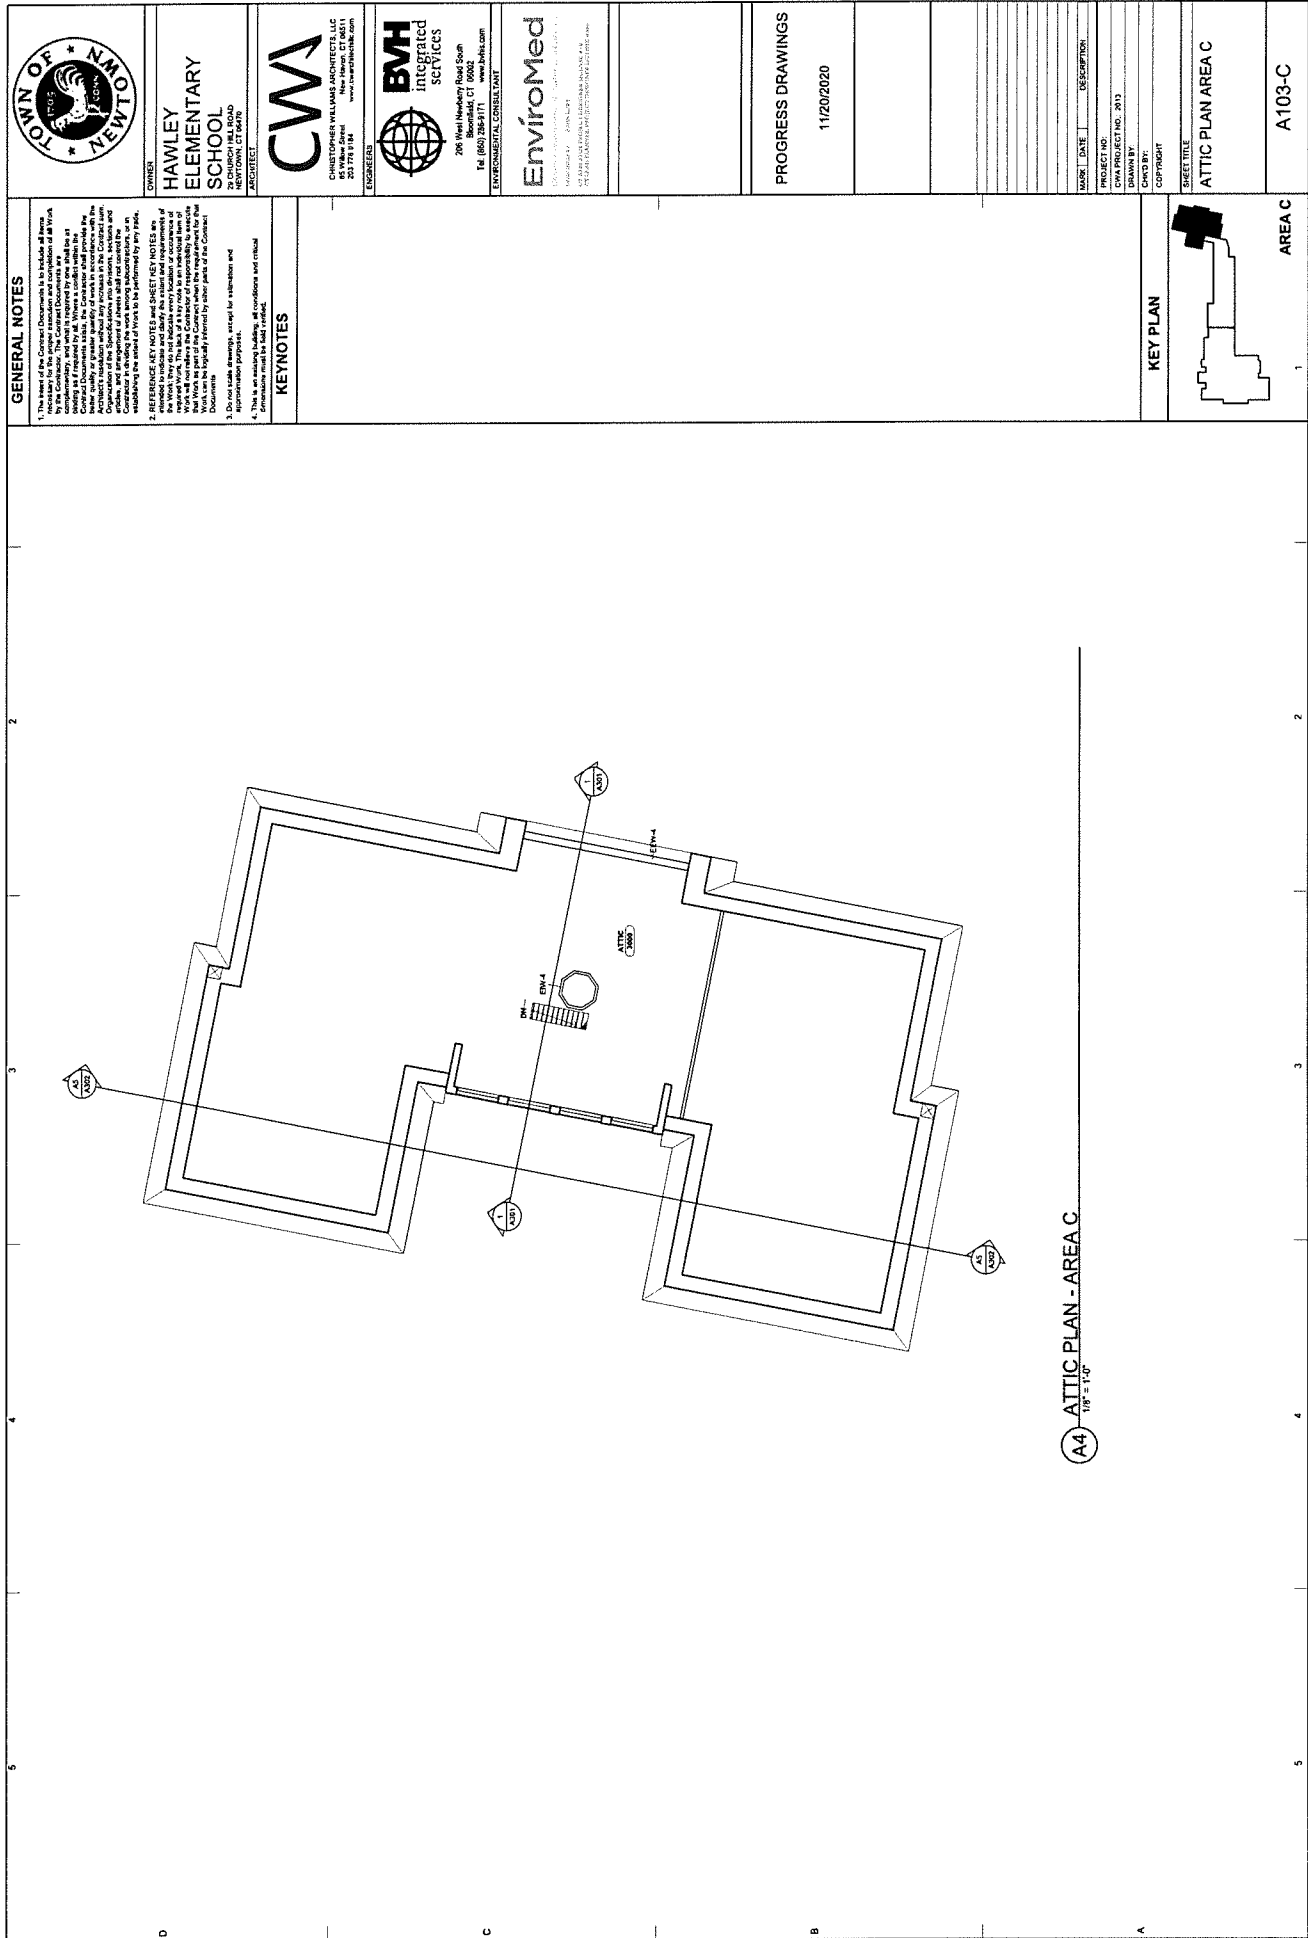
DATE:

SHEET TITLE

SECOND FLOOR PLAN

AREA C

A102-C




GENERAL NOTES

1. The Owner, the School District, is the sole authority for the proper location and completion of all work shown on this drawing. The Contractor shall be responsible for obtaining all necessary permits and for the proper location and completion of all work shown on this drawing. The Contractor shall be responsible for the proper location and completion of all work shown on this drawing. The Contractor shall be responsible for the proper location and completion of all work shown on this drawing.
2. The Contractor shall be responsible for the proper location and completion of all work shown on this drawing. The Contractor shall be responsible for the proper location and completion of all work shown on this drawing. The Contractor shall be responsible for the proper location and completion of all work shown on this drawing. The Contractor shall be responsible for the proper location and completion of all work shown on this drawing.
3. Do not scale drawings; use only dimensions and notes for construction and interpretation purposes.
4. This is an existing building; all conditions and details are shown as they exist.

KEYNOTES


KEY PLAN

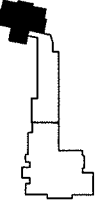

AREA C

1

A103-C



TOWN OF NEW MILFORD

HAWLEY ELEMENTARY SCHOOL

20 CHURCH HILL ROAD
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ARCHITECT

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PROGRESS DRAWINGS

11/20/2020

NO.	DATE	DESCRIPTION
1	11/20/2020	ATTIC PLAN - AREA C

PROJECT NO: CWA PROJECT NO. 2013

DRAWN BY: CWA

CHECKED BY: CWA


DATE: 11/20/2020

SHEET TITLE: ATTIC PLAN AREA C


SCALE: 1/8" = 1'-0"

GENERAL NOTES

1. The owner of the Contract Documents is to include all items necessary for the proper execution and completion of all work shown on the drawings and specified in the Contract Documents. The Contractor shall be responsible for obtaining all necessary permits, licenses, and approvals from the appropriate authorities. The Contractor shall be responsible for obtaining all necessary permits, licenses, and approvals from the appropriate authorities. The Contractor shall be responsible for obtaining all necessary permits, licenses, and approvals from the appropriate authorities.
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4. The Contractor shall be responsible for obtaining all necessary permits, licenses, and approvals from the appropriate authorities. The Contractor shall be responsible for obtaining all necessary permits, licenses, and approvals from the appropriate authorities. The Contractor shall be responsible for obtaining all necessary permits, licenses, and approvals from the appropriate authorities.

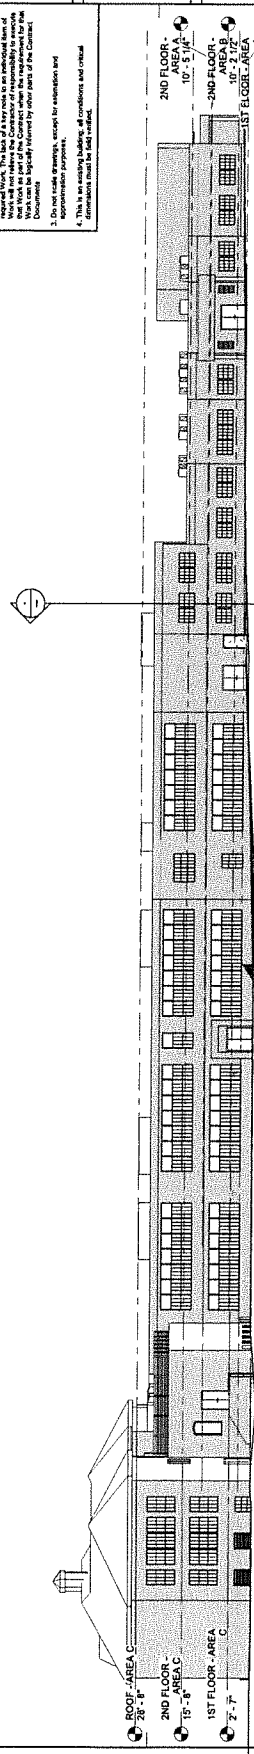

C5 NORTH ELEVATION (NEW)
1/16" = 1'-0"

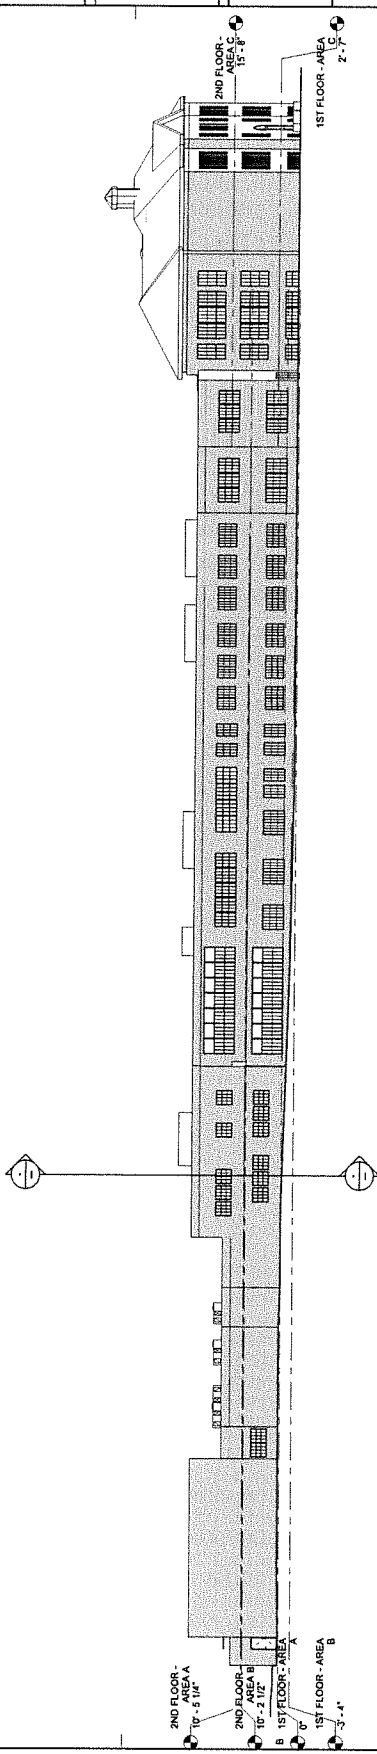

B5 SOUTH ELEVATION (NEW)
1/16" = 1'-0"



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137 ASHLEY AVENUE, SUITE 100
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PROGRESS DRAWINGS
11/20/2020

NO.	DATE	DESCRIPTION
1	11/20/2020	PROGRESS DRAWINGS

PROJECT NO.:
CWA PROJECT NO.: 2013
DRAWN BY:
CHECK BY:
CITY/STATE:
SHEET TITLE:
EXTERIOR ELEVATIONS

A201
11/20/2020 1:08:00 PM
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
GENERAL NOTES

1. The intent of the General Observations is to include all items necessary for the proper execution and completion of all Work in the Contract. The General Observations shall be read in conjunction with the Specifications, the Contract Documents, the General Notes, and the Notes to the General Notes. The General Notes shall provide the Contractor with a general overview of the project and the intent of the Specifications. The General Notes shall be read in conjunction with the Specifications and the Contract Documents. The Contractor shall be responsible for obtaining all necessary permits and approvals for the Work. The Contractor shall be responsible for obtaining all necessary permits and approvals for the Work. The Contractor shall be responsible for obtaining all necessary permits and approvals for the Work.

2. REFERENCES: ALL NOTES AND SPECIFICATIONS ARE REFERENCED TO THE CONTRACT DOCUMENTS. THE CONTRACT DOCUMENTS SHALL BE READ IN CONJUNCTION WITH THE SPECIFICATIONS AND THE CONTRACT DOCUMENTS. THE CONTRACT DOCUMENTS SHALL BE READ IN CONJUNCTION WITH THE SPECIFICATIONS AND THE CONTRACT DOCUMENTS. THE CONTRACT DOCUMENTS SHALL BE READ IN CONJUNCTION WITH THE SPECIFICATIONS AND THE CONTRACT DOCUMENTS.

3. Do not make changes, except for alterations and improvements, without the written approval of the Architect.

4. This is an existing building. All conditions and critical dimensions shall be as shown.




TOWN OF NEW MILFORD

**HAWLEY
ELEMENTARY
SCHOOL**

24 CHURCH HILL ROAD
NEW MILFORD, CT 06455


ARCHITECT



CWA

CHRISTOPHER WILLIAMS ARCHITECTS LLC
203 WILSON STREET
NEW MILFORD, CT 06455
203.775.0144
www.cwaarchitects.com

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ROOF - AREA C
25' x 8'


2ND FLOOR - AREA C
15' x 8'

1ST FLOOR - AREA C
2' x 7'

BASEMENT - AREA C
2' x 7'

BASEMENT - AREA C - LOWER
13' x 10'

(C5) EAST ELEVATION (NEW)
1/16" = 1'-0"

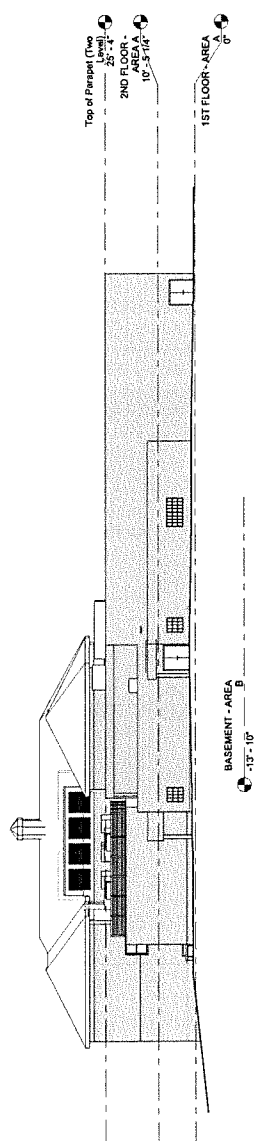

(B5) WEST ELEVATION (NEW)
1/16" = 1'-0"

BASEMENT - AREA C
13' x 10'

Top of Parapet (Two Levels)
25' x 8'

2ND FLOOR - AREA A
10' x 5' 1/4"

1ST FLOOR - AREA A
0'

PROGRESS DRAWINGS

11/20/2020

MARK	DATE	DESCRIPTION
CWA PROJECT NO.	2013	
DRAWN BY:		
CHECKED BY:		
DATE:		
COPYRIGHT		
SHEET TITLE		
EXTERIOR ELEVATIONS		

A202



**HAWLEY
ELEMENTARY
SCHOOL**
30 SCHOOL HILL ROAD
MIDDLETOWN, CT 06457

CWA
CHRISTOPHER WILLIAMS ARCHITECTS, LLC
100 MAIN STREET, SUITE 200
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TEL: (860) 386-3171
WWW.CWA-ARCHITECTS.COM

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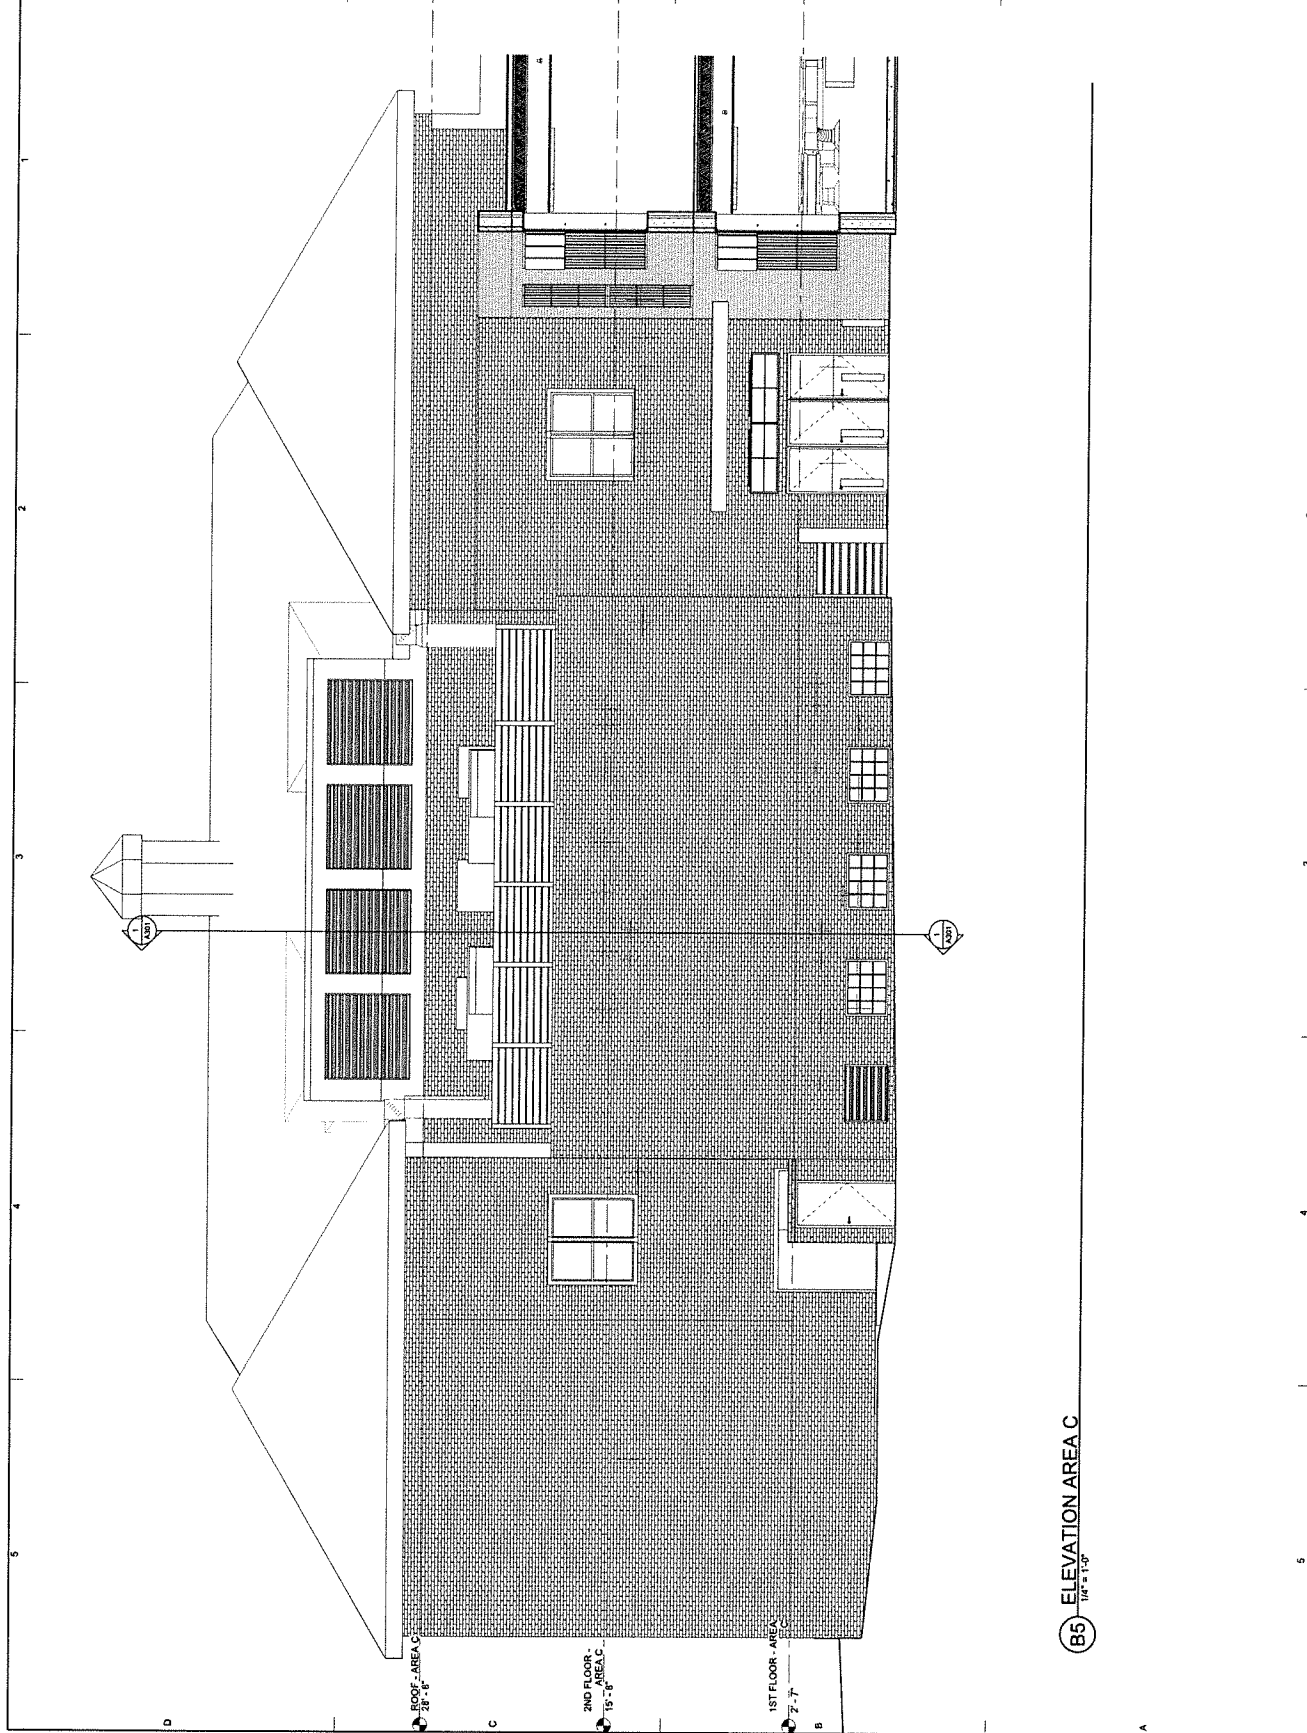
EnviroMed
CONSULTANTS
100 MAIN STREET, SUITE 200
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PROGRESS DRAWINGS
11/20/2020


MARK	DATE	DESCRIPTION
PROJECT NO.		CWA PROJECT NO. 2017
DRAWN BY:		CHAD BENT
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ELEVATION AREA C

A203



(B5) ELEVATION AREA C
1/4" = 1'-0"

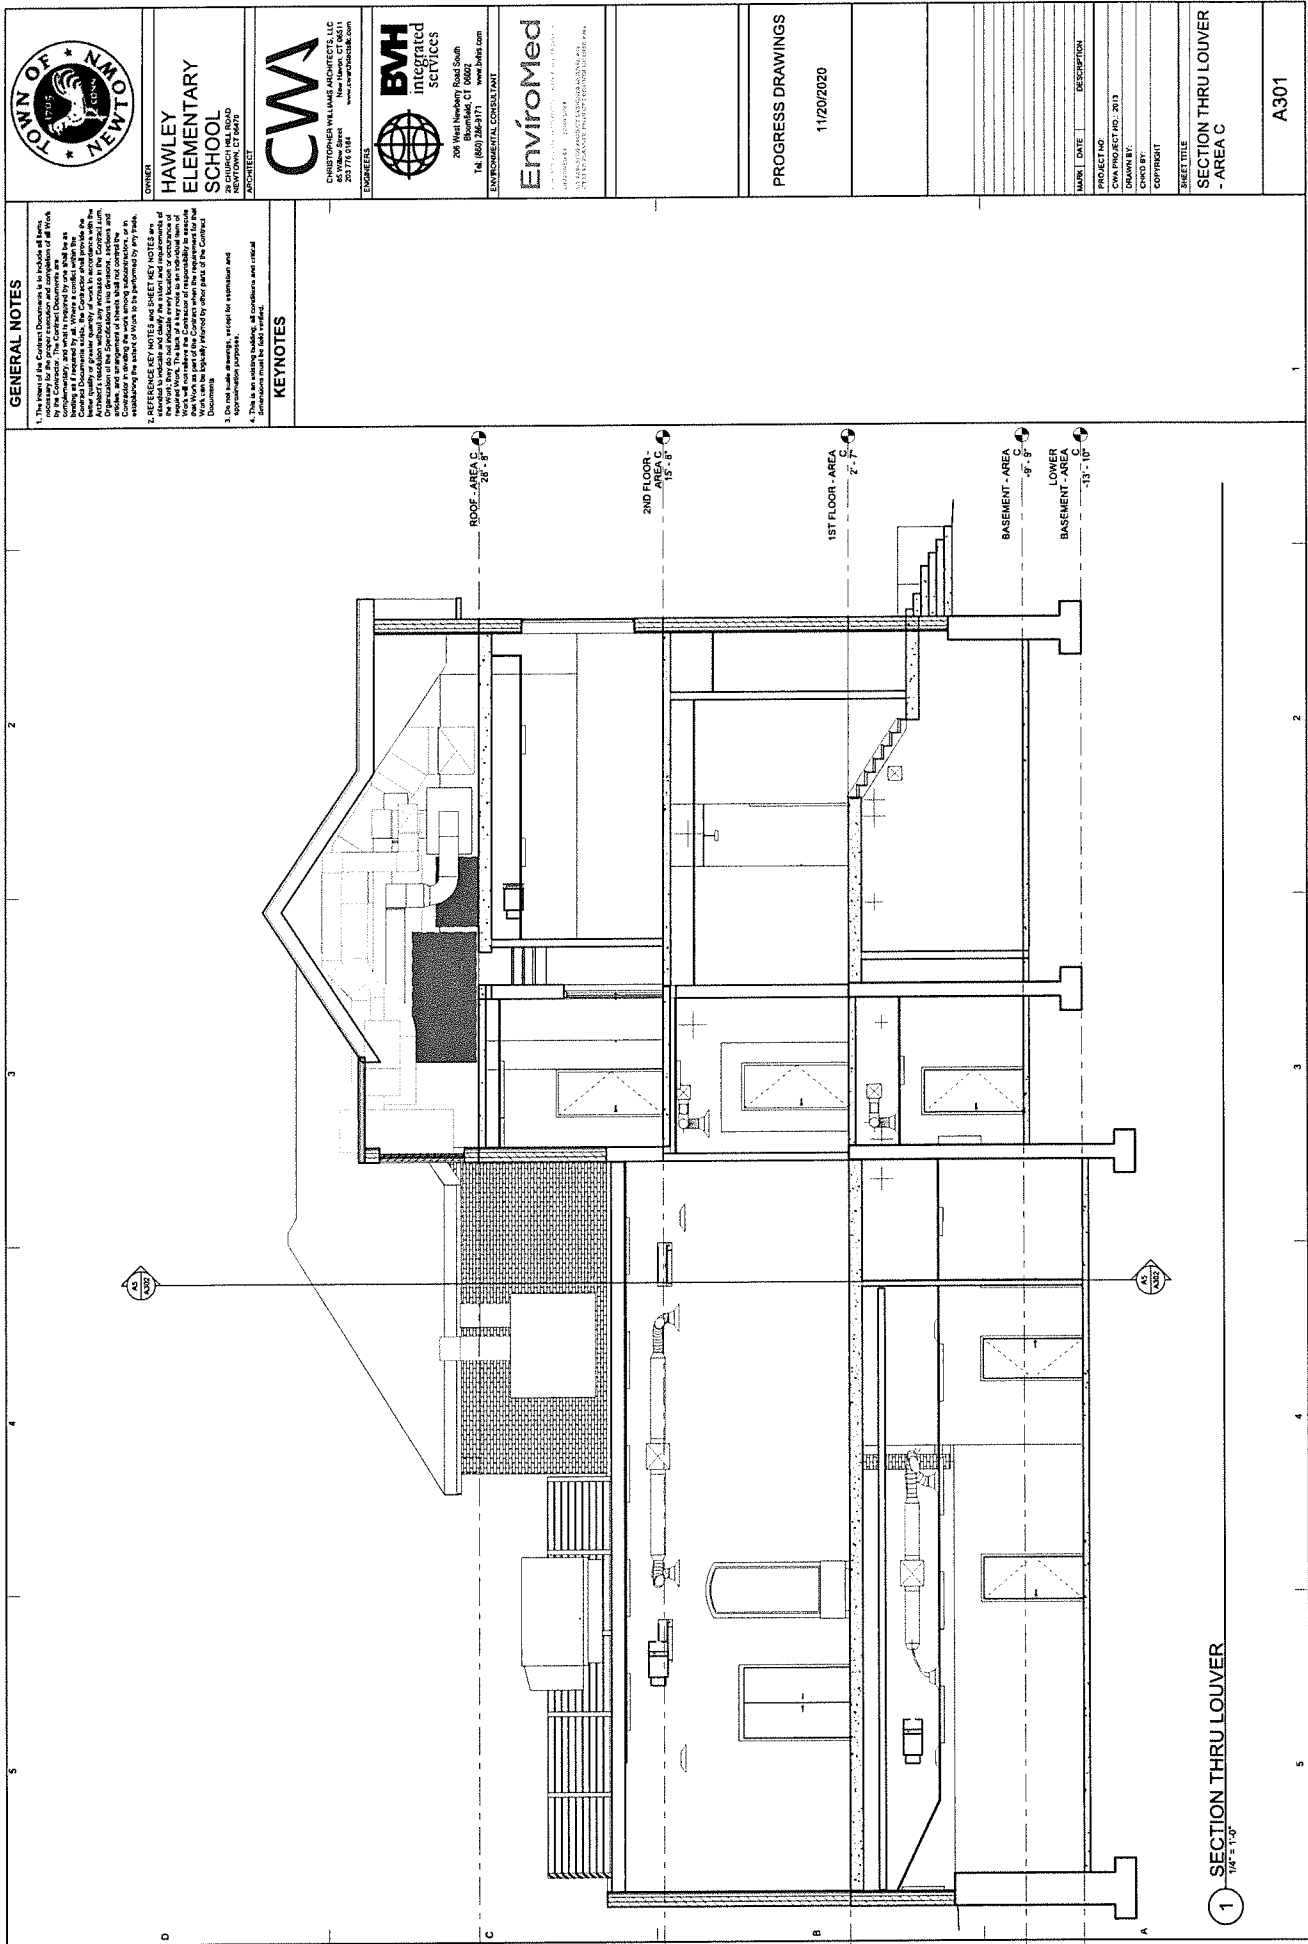


GENERAL NOTES


1. The intent of the Contract Documents is to include all items necessary for the proper execution and completion of all Work shown on the drawings and specified in the documents. The Contractor shall be responsible for obtaining all necessary permits, licenses, and approvals from the appropriate authorities. The Contractor shall be responsible for obtaining all necessary permits, licenses, and approvals from the appropriate authorities. The Contractor shall be responsible for obtaining all necessary permits, licenses, and approvals from the appropriate authorities.
2. REFERENCES KEY NOTES and SHEET KEY NOTES are intended to indicate and clarify the intent and requirements of the drawings and specifications. The Contractor shall be responsible for obtaining all necessary permits, licenses, and approvals from the appropriate authorities. The Contractor shall be responsible for obtaining all necessary permits, licenses, and approvals from the appropriate authorities. The Contractor shall be responsible for obtaining all necessary permits, licenses, and approvals from the appropriate authorities.
3. Do not make drawings, except for extension and approximation purposes.
4. This is an existing building. All conditions and critical details are shown as existing.

KEYNOTES


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
TOWN OF NEW MILFORD
20 CHURCH HILL ROAD
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45 WILLOW STREET
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11/20/2020

PROGRESS DRAWINGS

MARK	DATE	DESCRIPTION
PROJECT NO.		
CWA PROJECT NO.		
DATE		
DESIGNED BY		
CHECKED BY		
DATE		

SHEET TITLE

SECTION THRU LOUVER
- AREA C

A301

1 SECTION THRU LOUVER
1/4" = 1'-0"



OWNER
**HAWLEY
ELEMENTARY
SCHOOL**
39 CHURCH HILL ROAD
NEWTOWN, CT 06459

CWA
CHRISTOPHER WILLIAMS ARCHITECTS, LLC
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PROGRESS DRAWINGS


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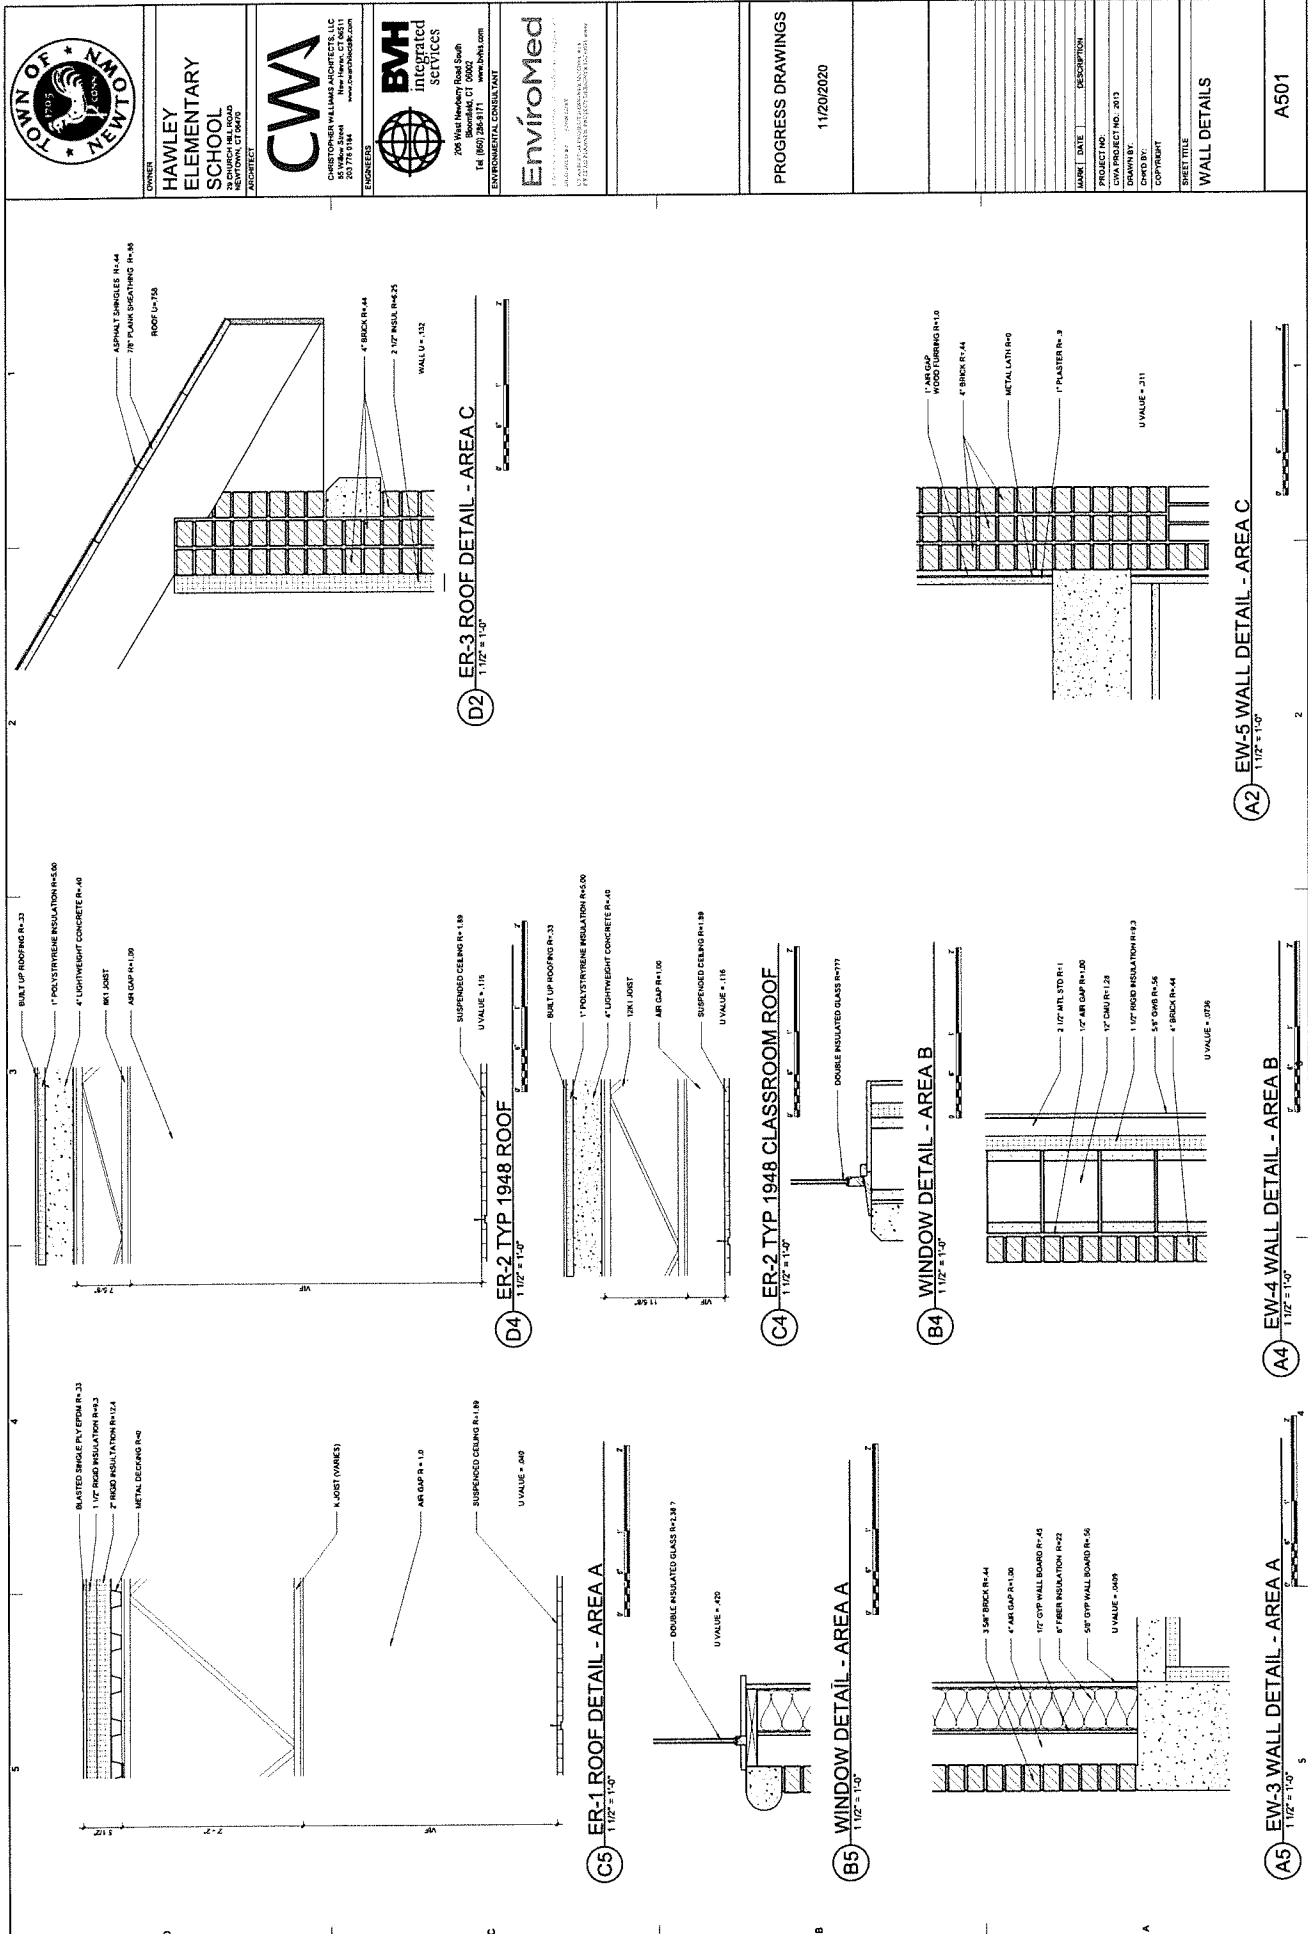
SHEET TITLE
**SECTION - AREA C
LOUVER**

A302

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A5 SECTION OF LOUVER
1/4" = 1'-0"



TOWN OF NEW MILFORD
 1935
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 Tel: (860) 286-9171
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PROGRESS DRAWINGS
 11/20/2020

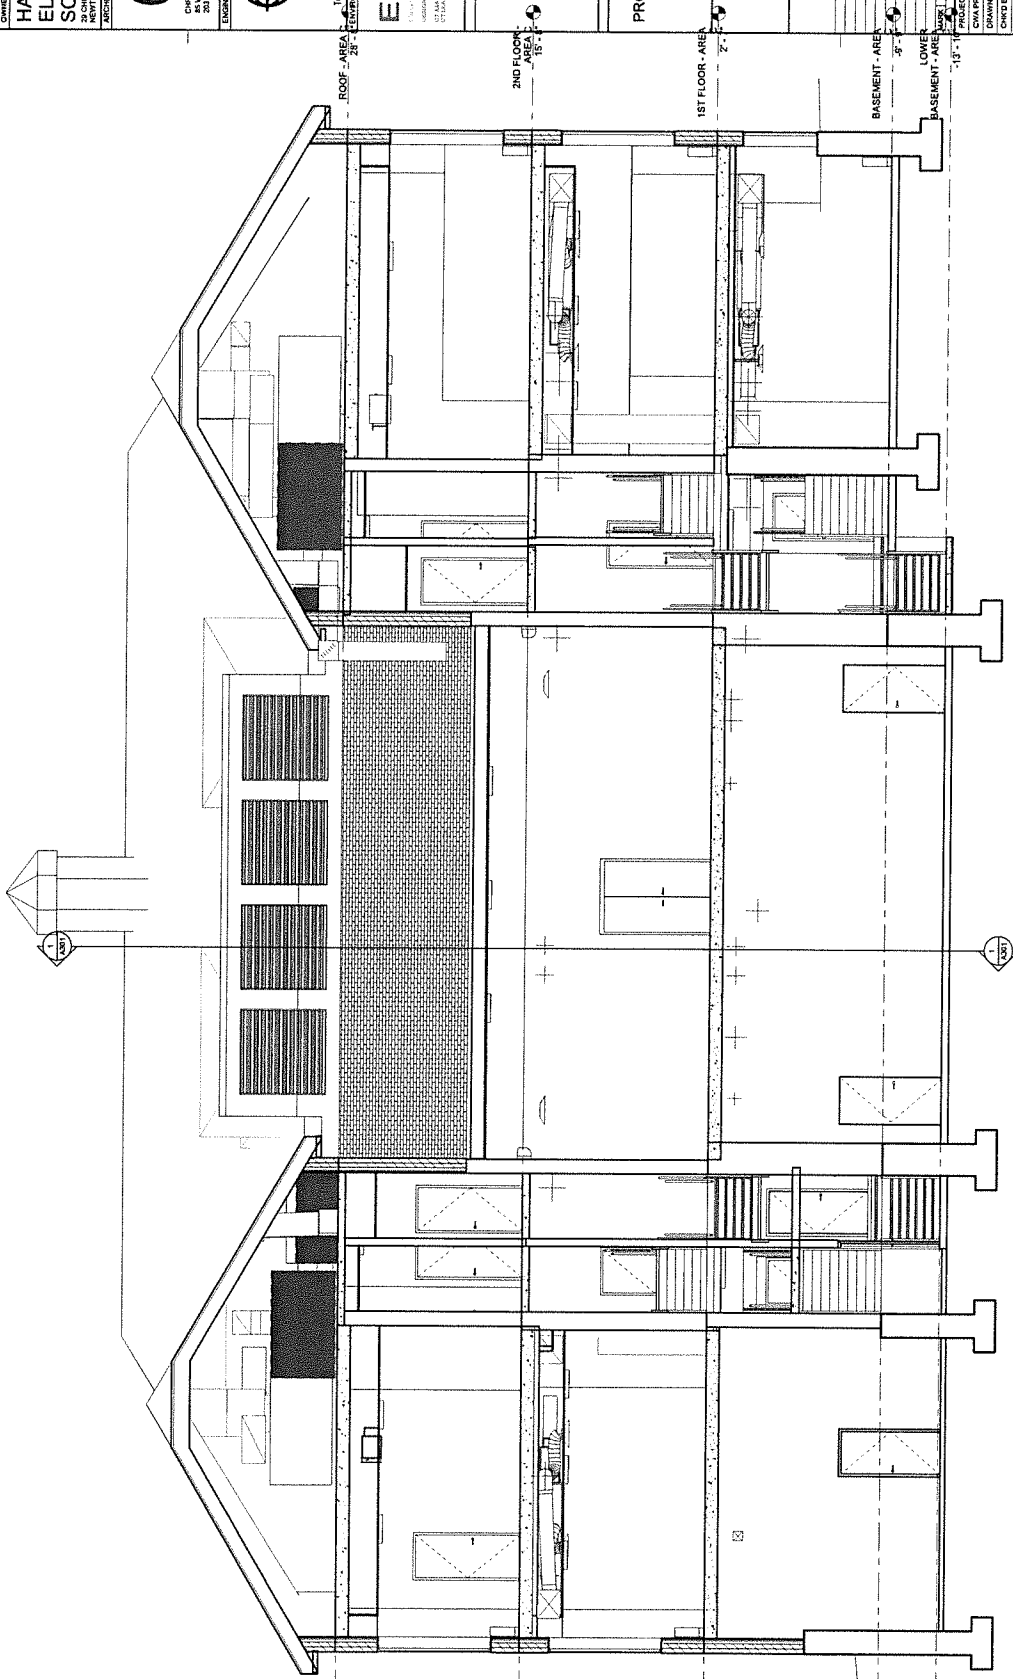PROJECT NO.
 CWA PROJECT NO. 2013

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 CWA

DATE
 11/20/2020

DESCRIPTION
 WALL DETAILS


SHEET TITLE
 WALL DETAILS

A501

CEILING HEIGHTS

ROOM NAME	ROOM #	A.F.F.	BO JST/SLB
-----------	--------	--------	---------------

AREA A - 1997	1104	8'-4"	4'-9"
TOLLET	1105	9'-0"	4'-7"
CORRIDOR	1106	9'-0"	4'-7"
STORAGE	1107	9'-0"	4'-7"
VESTIBULE	1108	9'-0"	4'-7"
CL. 1	1109	9'-0"	4'-7"
CL. 2	1110	9'-0"	4'-7"
CL. 3	1111	9'-0"	4'-7"
CL. 4	1112	9'-0"	4'-7"
CL. 5	1113	9'-0"	4'-7"
CL. 6	1114	9'-0"	4'-7"
CL. 7	1115	9'-0"	4'-7"
CL. 8	1116	9'-0"	4'-7"
CL. 9	1117	9'-0"	4'-7"
CL. 10	1118	9'-0"	4'-7"
CL. 11	1119	9'-0"	4'-7"
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CL. 13	1121	9'-0"	4'-7"
CL. 14	1122	9'-0"	4'-7"
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CL. 16	1124	9'-0"	4'-7"
CL. 17	1125	9'-0"	4'-7"
CL. 18	1126	9'-0"	4'-7"
CL. 19	1127	9'-0"	4'-7"
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CL. 248	1356	9'-0"	4'-7"
CL. 249	1357	9'-0"	4'-7"
CL. 250	1358	9'-0"	4'-7"
CL. 251	1359	9'-0"	4'-7"
CL. 252	1360	9'-0"	4'-7"
CL. 253	1361	9'-0"	4'-7"
CL. 254	1362	9'-0"	4'-7"
CL. 255	1363	9'-0"	4'-7"
CL. 256	1364	9'-0"	4'-7"
CL. 257	1365	9'-0"	4'-7"
CL. 258	1366	9'-0"	4'-7"
CL. 259	1367	9'-0"	4'-7"
CL. 260	1368	9'-0"	4'-7"
CL. 261	1369	9'-0"	4'-7"
CL. 262	1370	9'-0"	4'-7"
CL. 263	1371	9'-0"	4'-7"
CL. 264	1372	9'-0"	4'-7"
CL. 265	1373	9'-0"	4'-7"
CL. 266	1374	9'-0"	4'-7"
CL. 267	1375	9'-0"	4'-7"
CL. 268	1376	9'-0"	4'-7"
CL. 269	1377	9'-0"	4'-7"
CL. 270	1378	9'-0"	4'-7"
CL. 271	1379	9'-0"	4'-7"
CL. 272	1380	9'-0"	4'-7"
CL. 273	1381	9'-0"	4'-7"
CL. 274	1382	9'-0"	4'-7"
CL. 275	1383	9'-0"	4'-7"
CL. 276	1384	9'-0"	4'-7"
CL. 277	1385	9'-0"	4'-7"
CL. 278	1386	9'-0"	4'-7"
CL. 279	1387	9'-0"	4'-7"
CL. 280	1388	9'-0"	4'-7"
CL. 281	1389	9'-0"	4'-7"
CL. 282	1390	9'-0"	4'-7"
CL. 283	1391	9'-0"	4'-7"
CL. 284	1392	9'-0"	4'-7"
CL. 285	1393	9'-0"	4'-7"
CL. 286	1394	9'-0"	4'-7"
CL. 287	1395	9'-0"	4'-7"
CL. 288	1396	9'-0"	4'-7"
CL. 289	1397	9'-0"	4'-7"

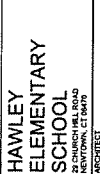

CWA
CHRISTOPHER WILLIAMS ARCHITECTS, LLC
New Haven, CT 06511
www.cwaarchitectsllc.com
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203.776.0184



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 WWW.ENVIROMED.COM


PROJECT STATUS

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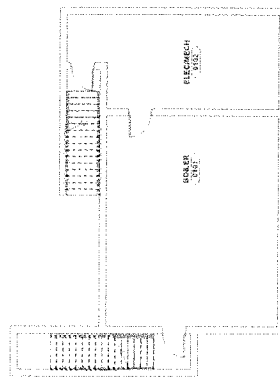
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HVAC BASEMENT PLAN

H100

11/20/2020 11:03:18 AM

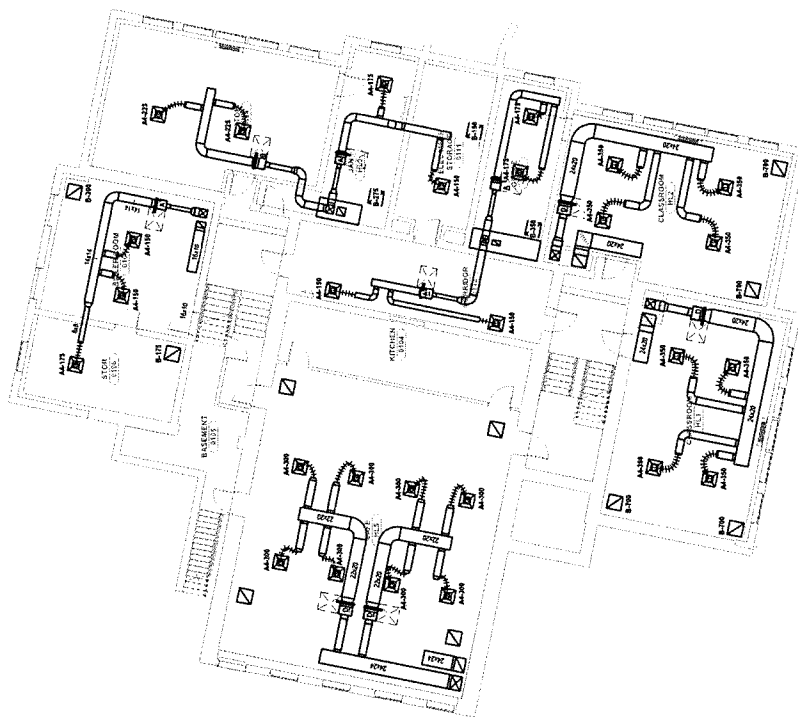

② HVAC - BASEMENT AREA C
1/8" = 1'-0"



1 HVAC - BASEMENT AREA B
1/8" = 1'-0"

KEY PLAN



AREA B AREA C

4100

U:\Users\JP\Icons\Documents\2120135 Hensley School - DVM MEP - P20 detached model QMS3.m



OWNER
**HAWLEY
ELEMENTARY
SCHOOL**
25 CHURCH HILL ROAD
NEW BRITAIN, CT 06050

ARCHITECT



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CONSTRUCTION MANAGEMENT
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ENGINEER



BMH
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DATE: 11/20/2011

PROJECT STATUS

ISSUE DATE

DATE DATE DESCRIPTION

PROJECT NO.

CWA PROJECT NO. 2011

DRAWN BY:

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CHECKED BY:

BMH

DATE:

11/20/2011

SHEET TITLE

HVAC FIRST FLOOR
PLAN AREA B

H101-B

KEY PLAN



AREA B


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400 CFM
16x8 SA&EA TO
EACH CLASSROOM

650 CFM
18x12 SA&EA TO ART
CLASSROOM

TYP LAYOUT TO
CONTINUE INTO AREA A

1. HVAC FIRST FLOOR AREA B
11/20/2011

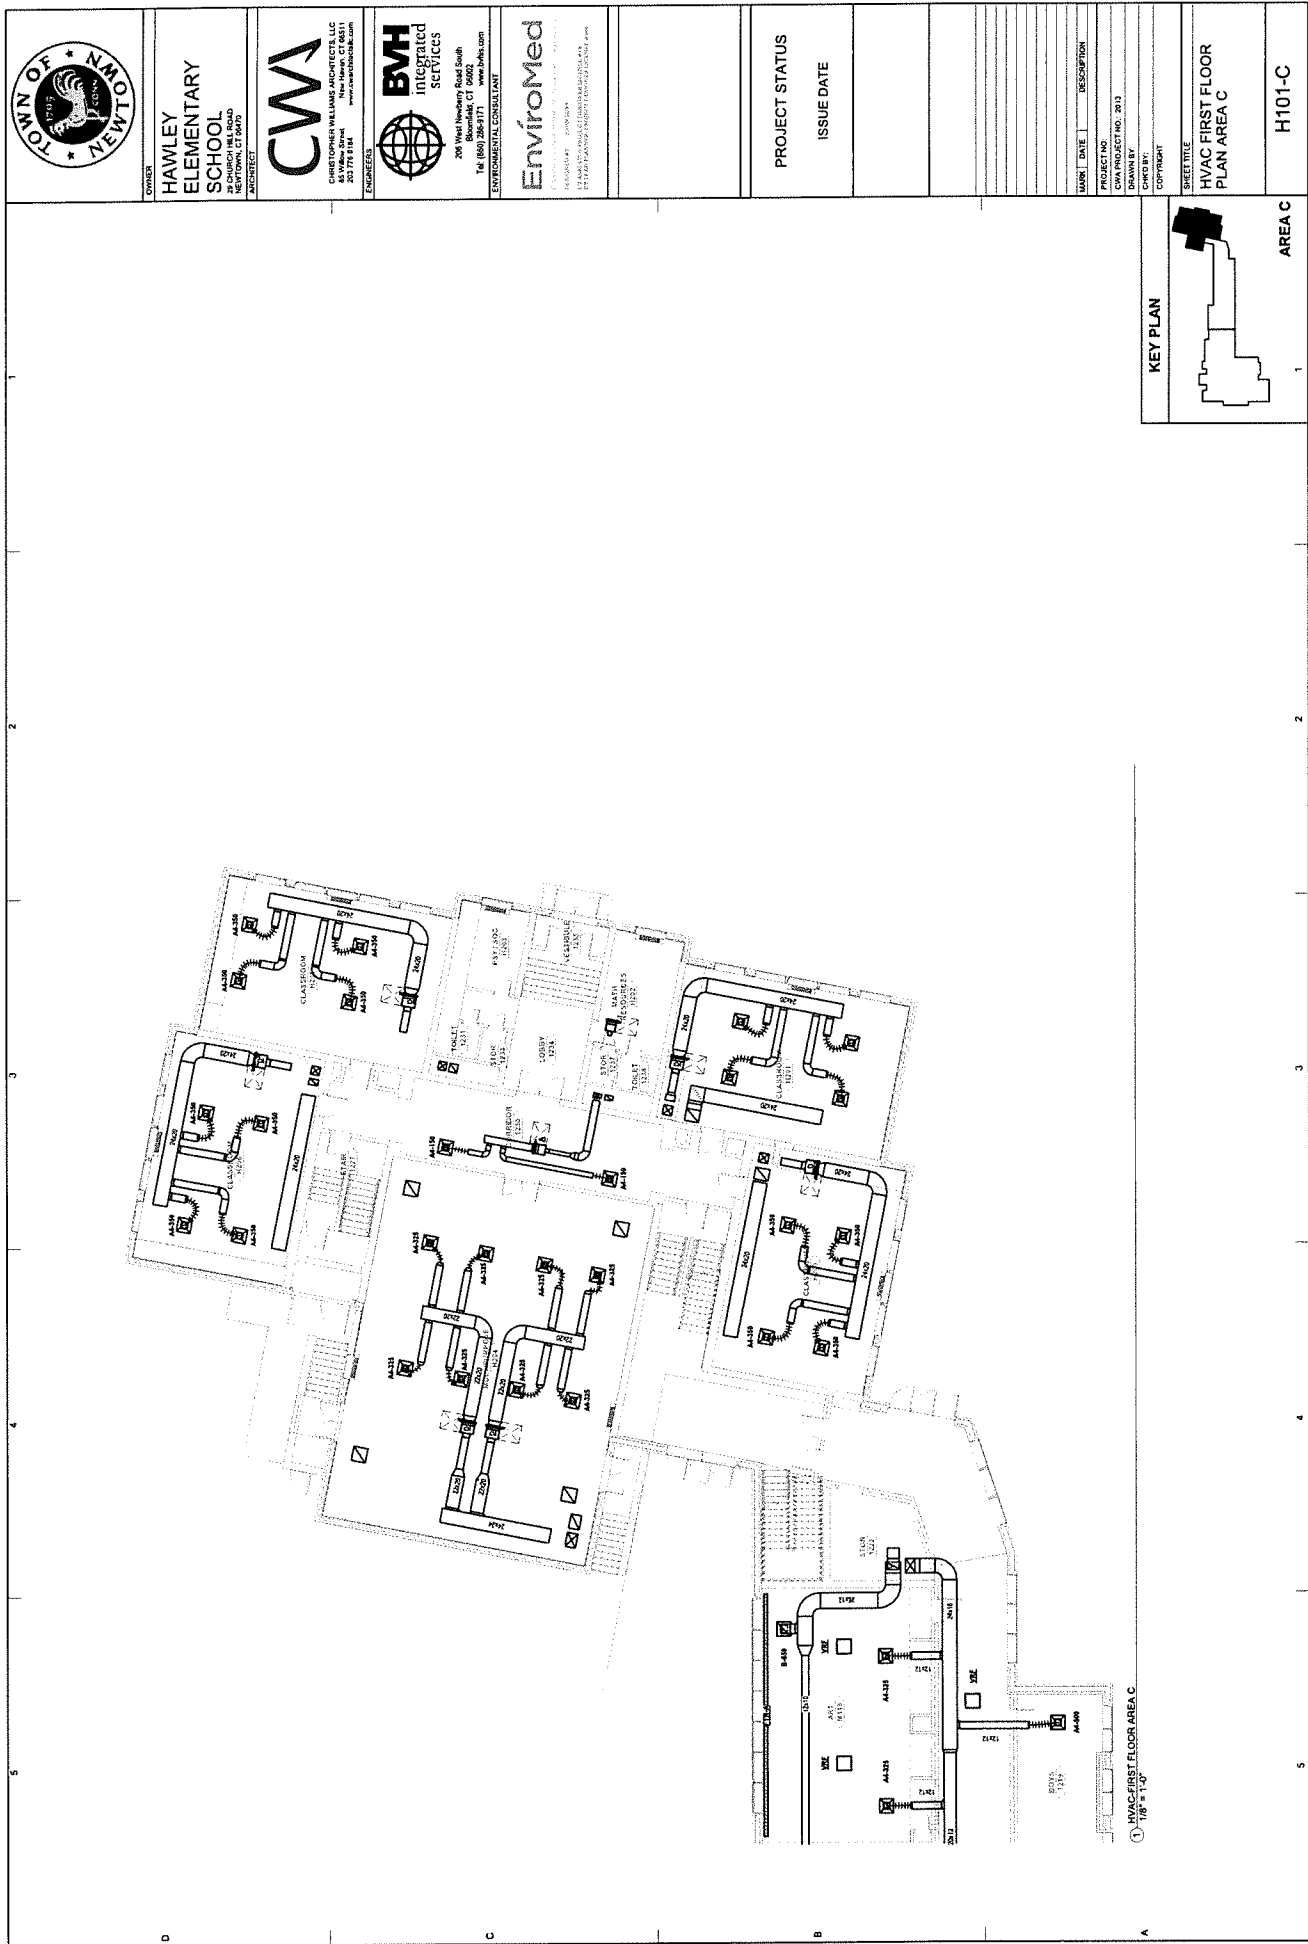

TOWN OF NEW MILFORD

OWNER

HAWLEY ELEMENTARY SCHOOL

20 HUNTER HILL ROAD
NEWTOWN, CT 06470

ARCHITECT

CWA

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Bloomfield, CT 06002
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www.bmh.com


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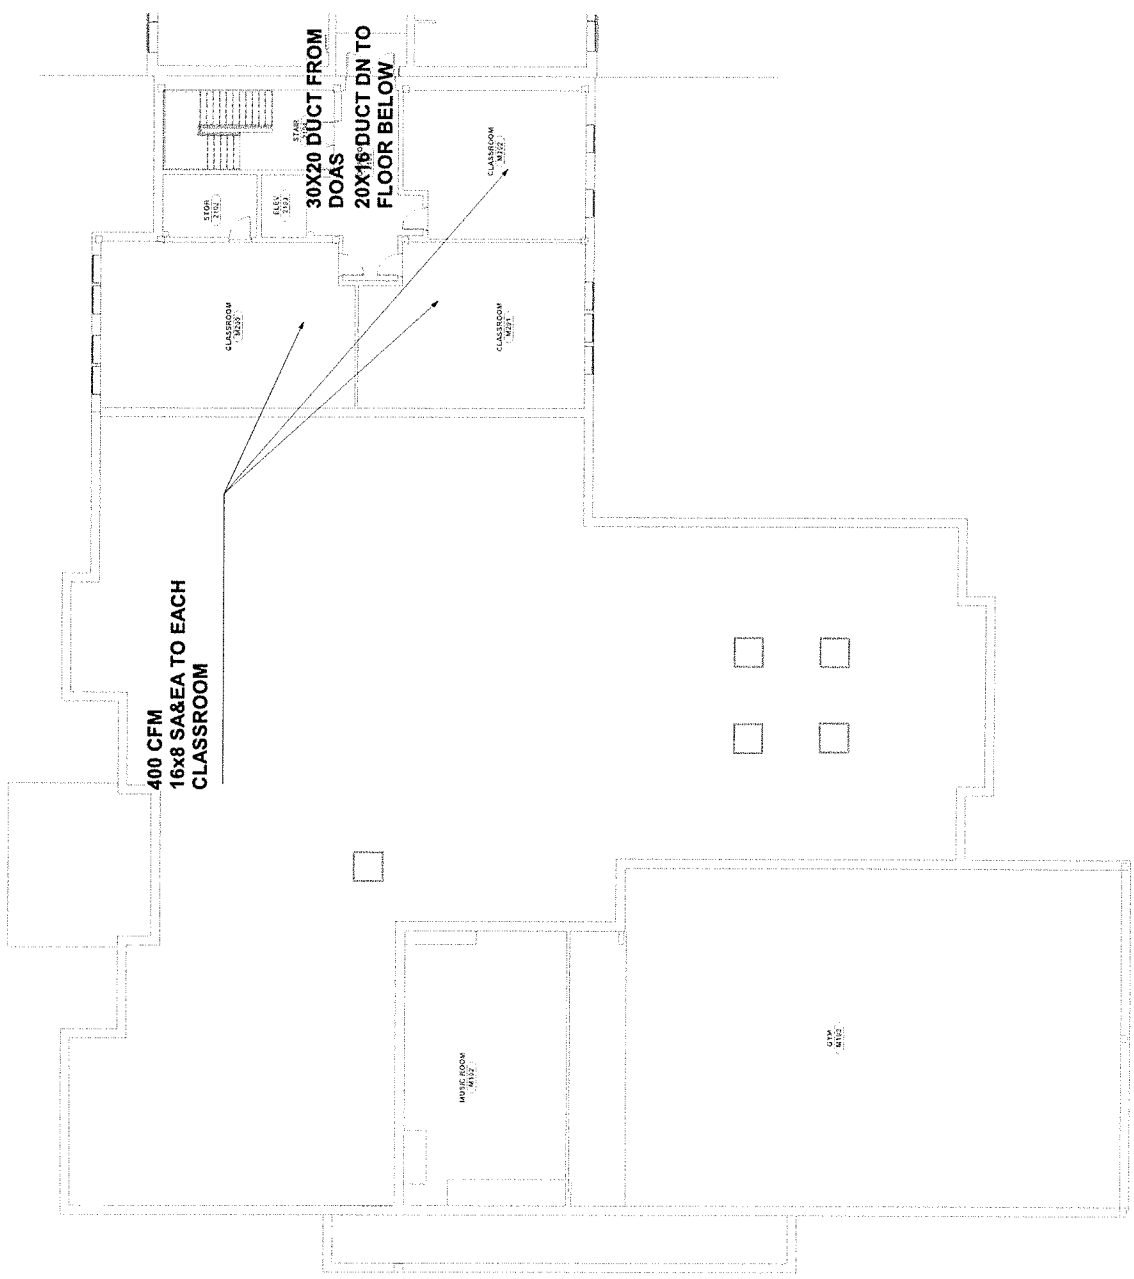
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SHEET TITLE
**HVAC SECOND FLOOR
PLAN AREA A**


H102-A



C:\Users\jason\Documents\120131\Hawley School - BMH MEP - 102 - second floor area A.dwg 11/20/2020 11:59:44 AM

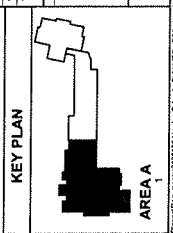

① HVAC SECOND FLOOR AREA A
1/8" = 1'-0"

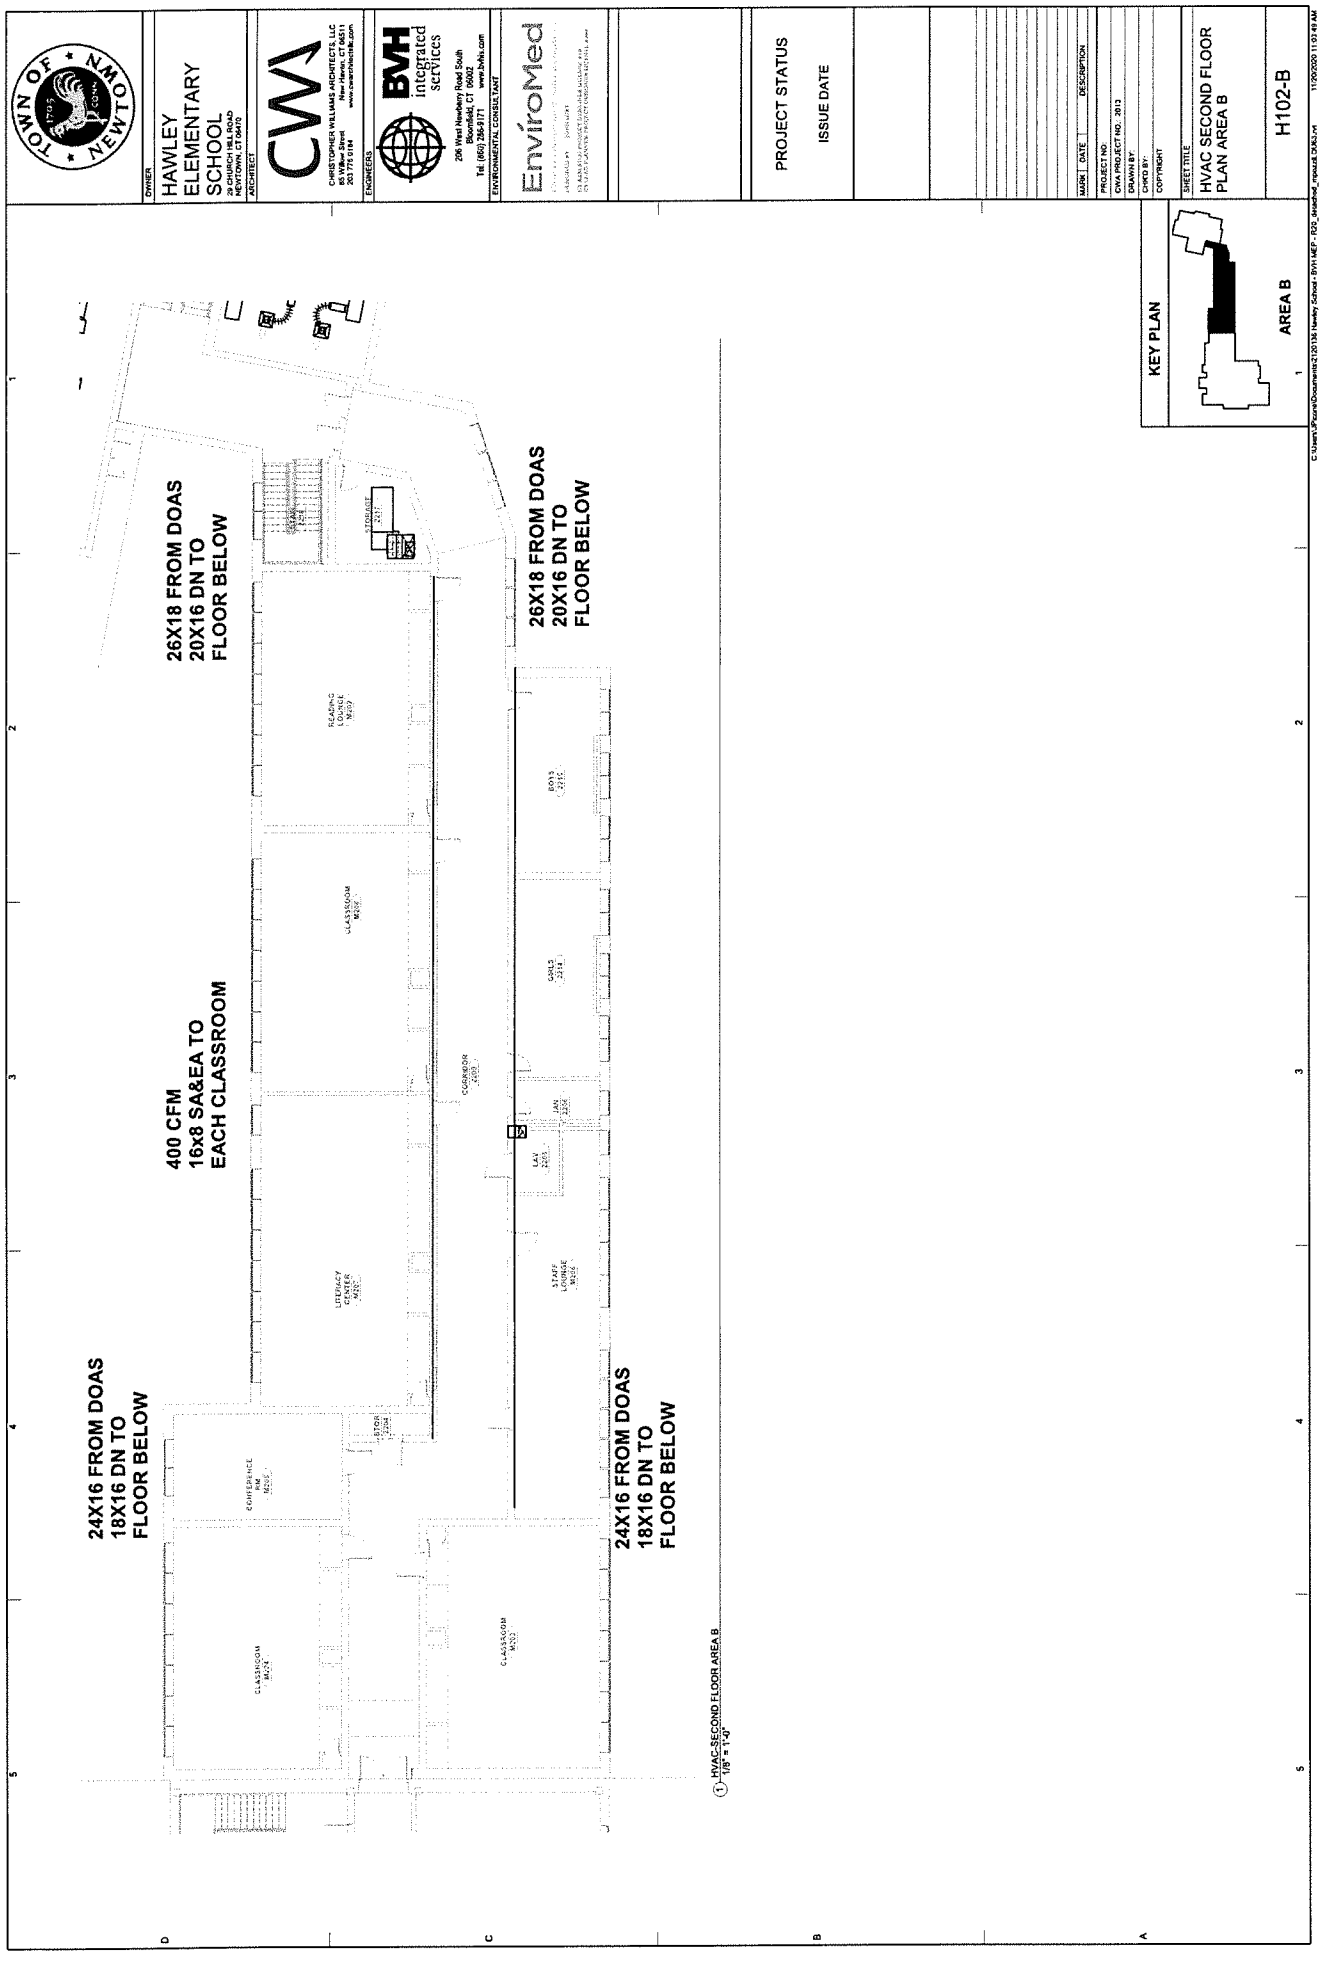

**HAWLEY
ELEMENTARY
SCHOOL**
NEWTON, CT 06455
ARCHITECT

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PROJECT STATUS

ISSUE DATE


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01/11/2013	PROJECT NO. CWA PROJECT NO. 2013
01/11/2013	DRAWN BY: CWA PROJECT NO. 2013
01/11/2013	CHECKED BY: CWA PROJECT NO. 2013
01/11/2013	DATE: 01/11/2013
01/11/2013	DESCRIPTION: HVAC SECOND FLOOR AREA B

KEY PLAN

AREA B



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HVAC SECOND FLOOR
PLAN AREA B

H102-B

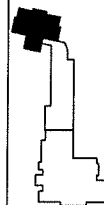


AREA C

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AREA C
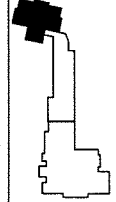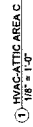
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


GENERAL NOTES

1. The intent of the Contract Documents is to provide all items necessary for the proper execution and completion of all work. The Contractor shall be responsible for obtaining all permits, fees, and approvals required for the work. The Contractor shall be responsible for obtaining all necessary permits, fees, and approvals required for the work. The Contractor shall be responsible for obtaining all necessary permits, fees, and approvals required for the work.
2. REFERENCE KEY NOTES and SHEET KEY NOTES are provided to indicate and clarify the intent and requirements of the Contract Documents. The Contractor shall be responsible for obtaining all necessary permits, fees, and approvals required for the work. The Contractor shall be responsible for obtaining all necessary permits, fees, and approvals required for the work.
3. Do not scale drawings, except for information and information purposes.
4. This is an existing building. All conditions and critical information are shown on the drawings.

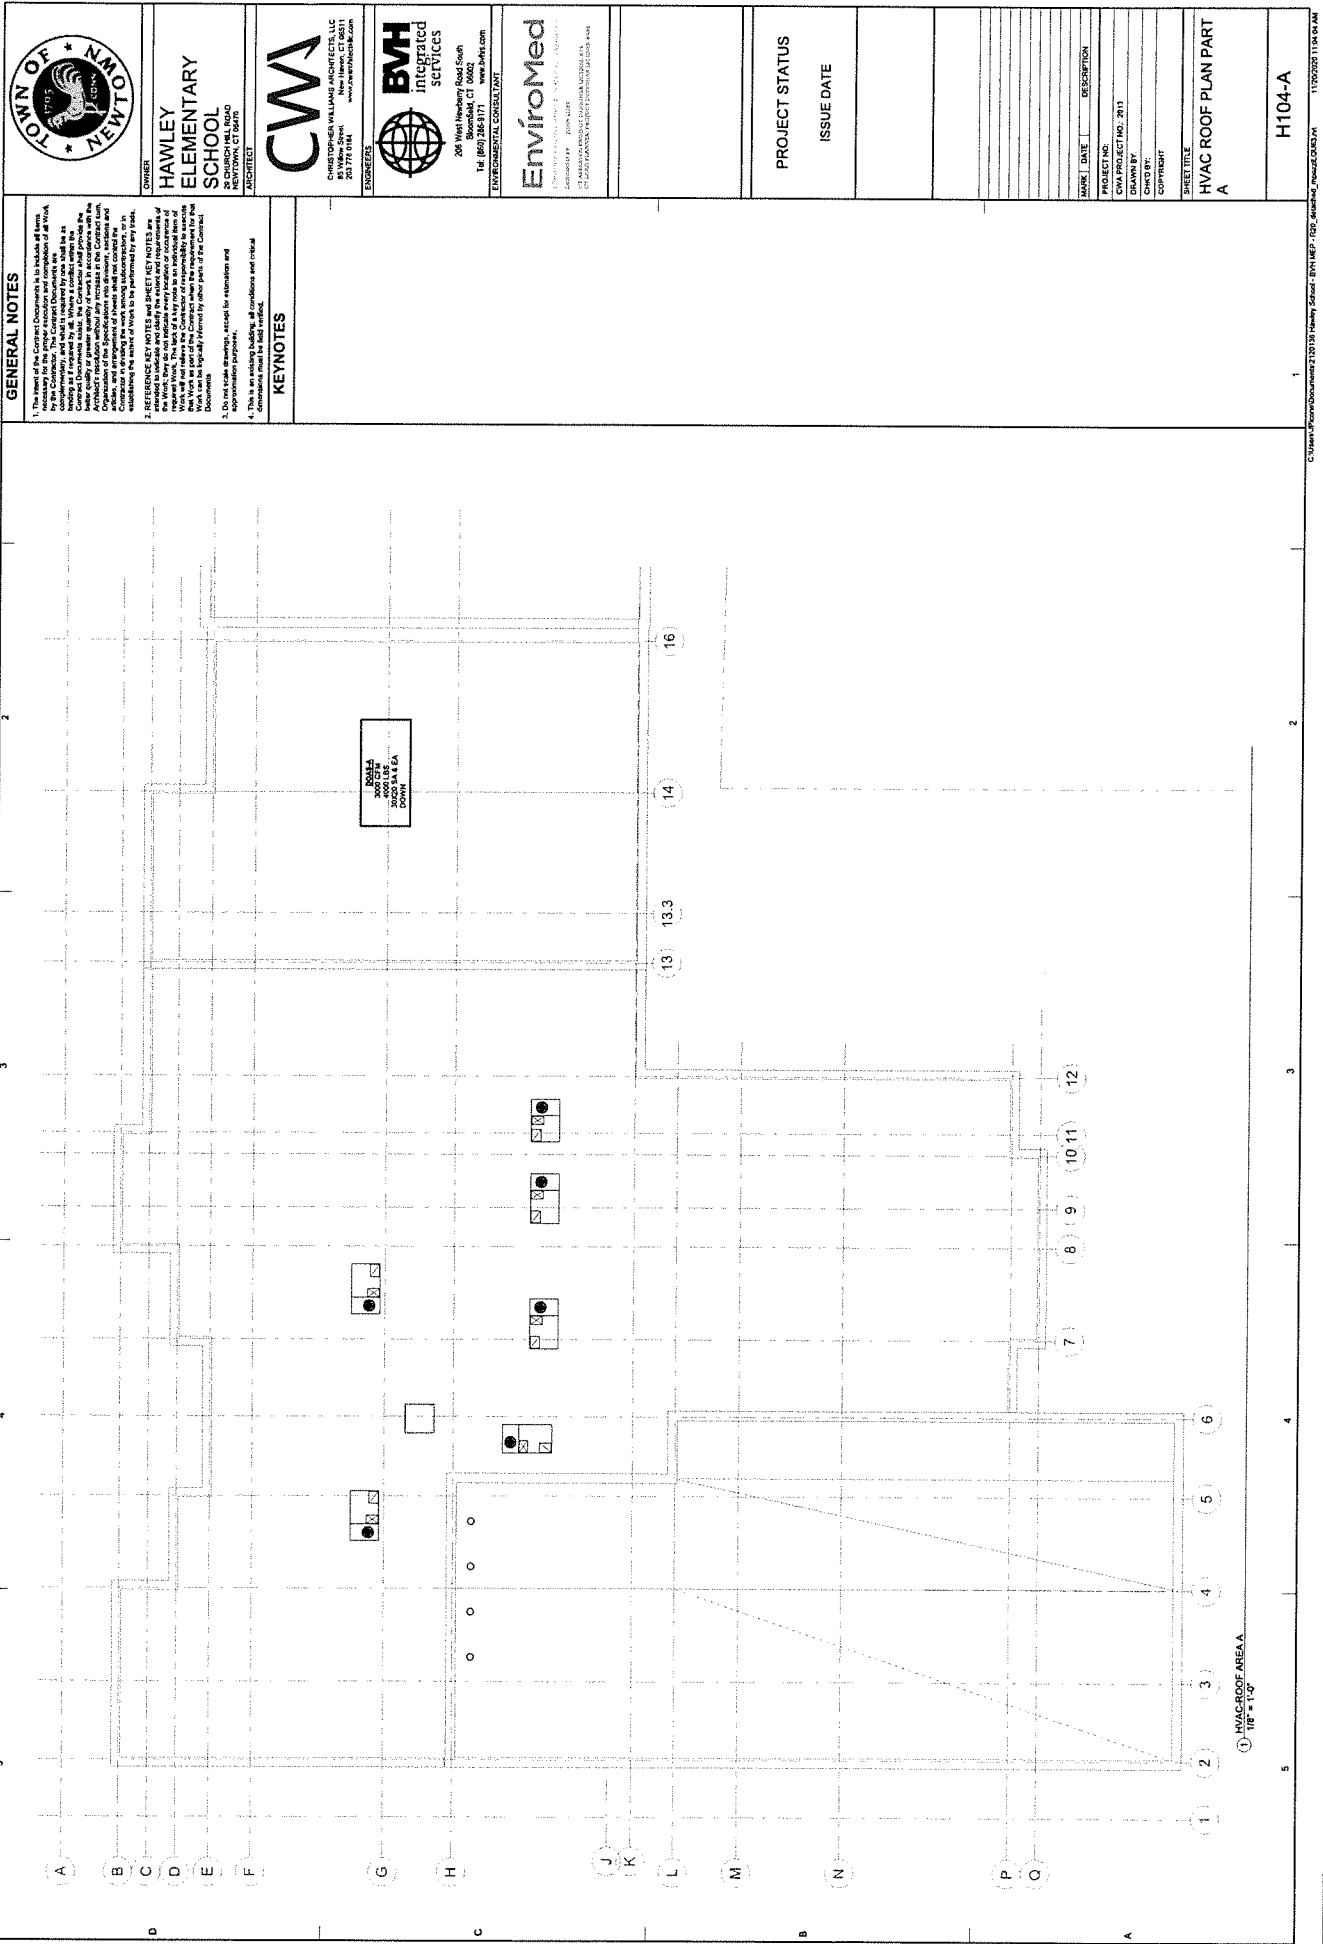KEYNOTES

1. This is an existing building. All conditions and critical information are shown on the drawings.



**TOWN OF
NEW MILFORD**

OWNER

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SCHOOL**

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INTERPRET
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ENVIRONMENTAL CONSULTANT


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HVAC ROOF PLAN PART A

SHEET NO.
H104-A



1. xxxxx

1. XXXXX

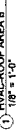